

CITY OF STOUGHTON DEPARTMENT OF PLANNING & DEVELOPMENT 381 East Main Street, Stoughton, WI. 53589

RODNEY J. SCHEEL DIRECTOR

(608) 873-6619

www.ci.stoughton.wi.us

Date: September 5, 2017

To: Planning Commissioners

From: Rodney J. Scheel

Director of Planning & Development

Michael P. Stacey

Zoning Administrator/Assistant Planner

Subject: Agenda Item for the September 11, 2017 Planning Commission Meeting.

Request by Craig Whitehead for a conditional use permit and site plan approval to install a fuel center for Pick n Save, 1750 US Highway 51 & 138.

This request is to install fuel pumps for Pick n Save in front of the Tractor Supply and Goodwill (formerly Walmart) retail sites. Kroger Foods owns Pick n Save and as part of their operation they offer incentives for patrons to purchase gas. In-vehicle sales or service uses are permitted as a conditional use. The site plan, staff review, resolution and related material are provided. The applicant has information from other Kroger Stores related to traffic impacts. Primary users of the fuel station are patrons of Pick n Save. The owner of the property is working with the tenants to decide what to do about freestanding signage. A public hearing and recommendation to Council are necessary. The Planning Commission has site plan review authority. Staff recommends any site plan decisions to be contingent on Council approval of the CUP and staff review letter.

CITY OF STOUGHTON, 381 E. MAIN STREET, STOUGHTON, WISCONSIN

RESOLUTION OF THE PLANNING COMMISSION Approving a site plan for Pick n Save Fuel Station at 1750 US Highway 51 - 138, Stoughton, WI. Committee Action: Planning Commission approves the site plan - 0 with the Mayor voting Fiscal Impact: File Number: R- 30 -2017 Date Introduced: September 11, 2017

RECITALS

- A. Craig Whitehead (the "Applicant") is seeking site plan approval for the installation of a fuel station for Pick n Save, 1750 US Highway 51 138 in the City of Stoughton, Dane County, Wisconsin (the "Property").
- B. The Property is zoned Planned Business which permits a fuel stations as a conditional use.
- C. The City Planning Commission reviewed and discussed the provided site plan at their regular September 11, 2017 meeting and found that the plan meets the intent of the Zoning Code and Comprehensive Plan.

RESOLUTION

BE IT RESOLVED, the City of Stoughton Planning Commission approves the site plan for a fuel station at 1750 US Highway 51 - 138, Stoughton, WI, subject to the staff review dated September 1, 2017 and Council approval of the conditional use permit.

Mayor Donna Olson	Date	
Planning Commission Chair		

CITY OF STOUGHTON, 381 E. MAIN STREET, STOUGHTON, WISCONSIN

RESOLUTION OF THE COMMON COUNCIL

Approving a Conditional Use Permit to allow an in-vehicle sales and service use (Fuel Station) for Pick n Save at 1750 US Highway 51 - 138, Stoughton, Wisconsin.

Committee Action: Planning Commission recommend Council approval -0

Fiscal Impact: None.

File Number: R- -2017 Date Introduced:

The City of Stoughton, Wisconsin, Common Council does proclaim as follows:

WHEREAS, on September 11, 2017 the City of Stoughton Planning Commission held a public hearing and reviewed the proposed conditional use permit request by Craig Whitehead, for property located at 1750 US Highway 51 - 138, Stoughton, Wisconsin; and

WHEREAS, the conditional use permit is requested to allow an in-vehicle sales and service use (Fuel Station); and

WHEREAS, the Zoning Administrator has determined:

- The proposed conditional use (the use in general and at the proposed specific location) is in harmony with the purposes, goals, objectives, policies and standards of the City of Stoughton comprehensive Plan, zoning ordinance or any other plan;
- The conditional use in its proposed location and as depicted on the required site plan does not result in a substantial or undue adverse impact on nearby property, the character of the neighborhood, environmental factors, traffic factors, parking, public improvements, public property or rights-of-way, or other matters affecting the public health, safety, or general welfare, either as they now exist or as they may in the future be developed as a result of the implementation of the provisions of this chapter, the comprehensive plan, or any other plan, program, map, or ordinance adopted or under consideration pursuant to official notice by the city of other government agency having jurisdiction to guide development;
- The proposed conditional use maintains the desired consistency of land uses, land use intensities, and land use impacts as related to the environs of the subject property;
- The proposed conditional use is located in an area that will be adequately served by and will not
 impose an undue burden on any of the improvements, facilities, utilities or services provided by
 public agencies serving the subject property;
- The potential public benefits of the proposed conditional use outweigh any and all potential adverse
 impacts of the proposed conditional use, after taking into consideration the applicant's proposal and
 any requirements recommended by the applicant to ameliorate such impacts; and

WHEREAS, the Planning Commission and Common Council determined the proposed conditional use permit will not create undesirable impacts on nearby properties, the environment, nor the community as a whole; now therefore

BE IT RESOLVED, by the City of Stoughton Common Council that the Conditional Use Permit request for Pick n Save to operate an in-vehicle sales and service use (Fuel Station) at 1750 US Highway 51 - 138, Stoughton, Wisconsin is hereby approved as presented.

Council Action: Adopt	ted Failed	Vote		_
Mayoral Action: Accep	t Veto			
Mayor Donna Olson	Date			
Council Action:	Override	Vote		

PUBLIC HEARING NOTICE

The City of Stoughton Planning Commission will hold a Public Hearing on Monday, September 11, 2017 at 6:00 o'clock p.m., or as soon after as the matter may be heard, in the Council Chambers, Public Safety Building, 321 South Fourth Street, Second Floor, Stoughton, Wisconsin, 53589, to consider a proposed conditional use permit application by Stoughton Pick, LLC, for an In-Vehicle Sales and Service use (Retail Fuel Center) for Pick n Save, 1750 US Highway 51 & 138, Stoughton, WI.

The property is more formally described as:

Parcel #281/0511-063-9821-2

Legal Description: PRT LOT 1 CSM 5317 CS24/144&146-8/4/87 DESCR AS SEC 6-5-11 PRT SE1/4SW1/4 COM SW COR SEC 6 TH ALG S LN SD SEC N87DEG00'14"E 1830.42 FT TH N02DEG00'20"W 71.72 FT TO N R/W USH 51 & SW COR CSM 5317 TH ALG SD R/W N89DEG10'52"E 180.94 FT TH ALG CRV TO LEFT RAD 5969.58 FT LC N88DEG25'27"E 147.14 FT TO POB TH N01DEG56'19"W 351.05 FT TH N21DEG47'04"W 45.70 FT TO SE COR WAL-MART BLDG TH N01DEG56'19"W 160.06 FT TO NE COR SD WAL-MART BLDG TH N01DEG56'19"W 219.52 FT TO N LN SD LOT 1 TH N89DEG06'11"E 211.03 FT TO W R/W KINGS LYNN RD & NE COR SD LOT 1 TH ALG CRV TO LEFT RAD 637.00 FT LC S31DEG26'57"E 72.81 FT TH S34DEG43'32"E 99.88 FT TH S34DEG37'32"E 148.97 FT TH ALG CRV TO RIGHT RAD 520.81 FT LC S20DEG31'01"E 255.24 FT TH S88DEG01'18"W 149.01 FT TH S02DEG10'22"E 74.96 FT TO NE COR LOT 2 SD CSM TH ALG N LN SD LOT 2 S89DEG46'21"W 184.00 FT TO NW COR SD LOT 2 TH S01DEG58'30"E 187.00 FT TO SW COR SD LOT 2 & N R/W USH 51 TH S89DEG48'41"W 64.24 FT TH ALG CRV TO RIGHT RAD 5969.58 FT LC S87DEG28'35"W 50.76 FT TO POB CONT 5.20 ACRES M/L (PICK N SAVE PARCEL) This property description is for tax purposes. It may be abbreviated. For the complete legal description please refer to the deed.

For questions regarding this notice please contact Michael Stacey, Zoning Administrator at 608-646-0421.

Additional information including a location map can be found at: http://stoughtoncitydocs.com/planning-commission/

Published August 17, 2017 Hub Published August 24, 2017 Hub

Written Description of the proposed conditional use



Proposed Pick'n Save Fuel Center

1750 US Highway 51 and 138


The proposed retail fuel center is a category extension, (like the deli, meat department, etc.) of the existing grocery operations and will be managed and staffed by well-trained grocery store employees. The parent company, Kroger, operates 1,400 grocery store fuel centers nationally, making them a bona fide petroleum marketer. Customers do not enter the fuel sales kiosk but complete transactions at the credit card readers at each fuel dispenser or at a transaction window located at the front of the transaction kiosk. There are proposed to be limited outdoor selling, i.e. ice, soda vending, dry goods on the exterior of the transaction kiosk and limited sales of convenience items from within the kiosk. The under ground petroleum storage tank system is designed, installed, and operated per local, state, and federal guidelines. The fuel center design is complementary to the grocery store with exterior lighting being dark-sky compliant and wholly on our site.

Pick n Save Pumps



August 14, 2017

Tax Parcels

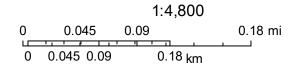

Sources: Esri, HERE, DeLorme, Intermap, increment P Corp., GEBCO, USGS, FAO, NPS, NRCAN, GeoBase, IGN, Kadaster NL, Ordnance Survey, Esri Japan, METI, Esri China (Hong Kong), swisstopo, MapmyIndia, © OpenStreetMap contributors, and the GIS User Community

Pick'n Save 534-00390 **Retail Fuel Center**

1750 Hwy. 51 West Stoughton, Wisconsin 53589







ZONING MAP

SITE ZONING: PLANNED BUSINESS

CONSTRUCTION OF A RETAIL FUEL CENTER AND SHOPPING CENTER SITE CONSISTING OF: ONE (1) 3,480 SF CANOPY

 ONE (1) 178 SF KIOSK BUILDING FIVE (5) DISPENSER ISLANDS

SITE NOTES:

FUEL CENTER OPERATIONS WILL UTILIZE STORE TRASH DUMPSTER. THE BOUNDARY LINES AND TOPOGRAPHY FOR THIS PROJECT ARE BASED ON A FIELD SURVEY COMPLETED BY JSD PROFESSIONAL SERVICES INC. PROJECT NUMBER 14-6271 AS PROVIDED BY THE CROWN GROUP. THE CONTRACTOR SHALL VERIFY THE EXISTING CONDITIONS PRIOR TO CONSTRUCTION AND SHALL IMMEDIATELY NOTIFY ENGINEER AND OWNER IN WRITING IF CONFLICTS EXIST.

DEVELOPMENT NOTES PROJECT DIRECTORY

BUILDING CODE REVIEW:

BUILDING CODE: **ELECTRICAL CODE:** MECHANICAL CODE: PLUMBING CODE: FUEL/GAS CODE: FIRE SPRINKLER:

ANSI/ICC A117.1 - 2009 INTERNATIONAL BUILDING CODE - 2012 NFPA NATIONAL ELECTRICAL CODE - 2011 INTERNATIONAL MECHANICAL CODE - 2012 INTERNATIONAL PLUMBING CODE - 2009 INTERNATIONAL FUEL GAS CODE - 2012 NFPA 13 - FIRE SPRINKLER CODE

A.M., ISSUE DATE: JULY 14, 2014)

FOR INFORMATIONAL PURPOSES ONLY:

ADDRESS: 1750 AND 1800 US HIGHWAY 51, STOUGHTON, WI

TAX KEY NUMBER: 281/0511-063-9801-5 AND 281/0511-063-9810-2

LEGAL DESCRIPTION

PARCEL 1:

WISCONSIN.

PARCEL 2:

ZONING ORDINANCE: MUNICIPAL CODE OF THE CITY OF STOUGHTON, WISCONSIN ADPOTED: OCTOBER 14, 2003.

ZONING MAP CITY OF STOUGHTON ZONING MAP: MARCH 19, 2015

SITE ZONING: PLANNED BUISINESS

PERMITTED USE: CONDITIONAL USE - USE WOULD COMPLY WITH FUTURE LAND USE MAP WHERE AREA IS DESCRIBED AS PLANNED MIXED USE.

DESIGN CRITERIA

BULK REGULATIONS			
LOT DIMENSIONS:	MINIMUM:	100' LOT WIDTH	SECTION 78-105-8-b-B
	ACTUAL:	180.94'	
LOT AREA:	MINIMUM:	20,000 SF	SECTION 78-105-8-b-A
	ACTUAL:	474,637 SF	
FLOOR AREA	KIOSK: 188 SF	PICK'N SAVE: 51,135 SF	TRACTOR SUPPLY/GOODWIL 42,172 SF
FAR	MAX: 1	ACTUAL: .2	SECTION 78-105-8-A
IMPERVIOUS AREA		ACTUAL: 355,539 SF	
LSR	MIN: .25	ACTUAL: .25	SECTION 78-105-8-A
BUILDING HEIGHT:	MAXIMUM:	45.0' (2 STORIES)	SECTION 78-105-8-b-N
	ACTUAL:	11.0'	
CANOPY HEIGHT:	MAXIMUM:	45.0'	SECTION 78-105-8-b-M
	ACTUAL:	19.0'	
SETBACKS - BUILDING			
FRONT YARD:	MINIMUM:	20.0'	SECTION 78-105-4-b
	ACTUAL:	58.52'	
SIDE YARD:	MINIMUM:	10.0'	SECTION 78-105-4-b
	ACTUAL:	123.26' WEST 80.32' EAST	
REAR YARD:	MINIMUM:	20.0'	SECTION 78-105-4-b
	ACTUAL:	85.23'	
SETBACKS - CANOPY			
FRONT YARD:	MINIMUM:	10.0'	SECTION 78-105-4-g
	ACTUAL:	58.52'	
SIDE/REAR YARDS	MINIMUM:	5.0'	SECTION 78-105-4-g
	ACTUAL:	42.34' WEST 24.41' EAST 71.40' SOUTH (REAR)	
LOADING ZONE:			
SIZE:	MINIMUM:	10' x 50'	SECTION 78-705-4

BULK REGULATIONS

10' x 50'

ACTUAL:

	OWNER	THE CROWN GROUP 1564 WEST ALGONQUIN ROAD HOFFMAN ESTATES, IL 60192	CRAIG WHITEHEAD CCIM,CPM,CRX 847.934.2525
	DEVELOPER	MARIANO'S 875 E. WISCONSIN MILWAUKEE, WI 53202	NATALIE MOUW 317.710.6255
SITE	PROJECT CONSULTANT	SEVAN MULTI-SITE SOLUTIONS 37704 HILLS TECH DRIVE FARMINGTON HILLS, MI 48331	TIM KRATZ, P.E. 586.630.7212
	SURVEYOR	JSD PROFESSIONAL SERVICES, INC. 161 HORIZON DR STE 101 VERONA, WI 53593	608.848.5060
	CIVIL ENGINEER	SEVAN MULTI-SITE SOLUTIONS 37704 HILLS TECH DRIVE FARMINGTON HILLS, MI 48331	TIM KRATZ, P.E. 586.630.7212
) IONAL	FUEL ARCHITECT	GALLOWAY 6162 S. WILLOW DRIVE, SUITE 320 GREENWOOD VILLAGE, CO 80111	DAVID JONES 303.770.8884
REGISTERED DESIGN PROFESSIONAL	TANK AND PIPING	GALLOWAY 6162 S. WILLOW DRIVE, SUITE 320 GREENWOOD VILLAGE, CO 80111	DAVID JONES 303.770.8884
R DESIGI	KIOSK VENDOR	VENTAIRE, LLC 909 N. WHEELING AVENUE TULSA, OK 74110	RALPH HIBBERD 918.858.1407
	CANOPY VENDOR	McGEE CORPORATION 12701 EAST INDEPENDENCE BLVD. MATTHEWS, NC 28106	CANDACE BOYCE 704.884.1500

(CHICAGO TITLE INSURANCE COMPANY, FILE No.: 141015, EFFECTIVE DATE: JULY 06, 2014 AT 12:01 LOT 1 OF CERTIFIED SURVEY MAP 5317, RECORDED IN VOLUME 24 OF CERTIFIED SURVEY MAPS, PAGE 144, AS DOCUMENT No. 2036861, BEING A PART OF THE SOUTHEAST 1/4 OF THE SOUTHWEST 1/4 OF SECTION 6, TOWNSHIP 5 NORTH, RANGE 11 EAST, IN THE CITY OF STOUGHTON, DANE COUNTY, NON-EXCLUSIVE EASEMENTS FOR INGRESS AND EGRESS AS CONTAINED IN CROSS-EASEMENT AGREEMENT WITH COVENANTS AND RESTRICTIONS CONTAINED IN INSTRUMENT RECORDED DECEMBER 14, 1988, IN VOLUME 12297 OF RECORDS, PAGE 46, AS DOCUMENT No. 2118693 AND RE-RECORDED ON JANUARY 18, 1989, IN VOLUME 12418 OF RECORDS, PAGE 1, AS DOCUMENT No. 2123640.

COVER SHEET GENERAL NOTES ALTA/ACSM LAND TITLE SURVEY COMPOSITE SITE PLAN - CONSTRUCTION DEMOLITION SITE PLAN SOIL EROSION AND SEDIMENT CONTROL PLAN DIMENSION CONTROL SITE PLAN GRADING PLAN UTILITY PLAN SITE DETAILS SITE DETAILS LANDSCAPE PLAN LANDSCAPE DETAILS AND SPECIFICATIONS LO-139216 PHOTOMETRIC PLAN **STANDARD DETAILS - CITY OF STOUGHTON** ARCHITECTURAL ARCHITECTURAL GRAPHICS AG1.01 SIGN PLAN - SITE SIGN ELEVATIONS - EXTERIOR AG5.01 SIGN DETAILS **ARCHITECTURAL** CONSTRUCTION & FOUNDATION PLANS FLOOR & EQUIPMENT PLANS CEILING/FINISH, MECHANICAL, ROOF PLANS & DETAILS EXTERIOR ELEVATIONS **EXTERIOR ELEVATIONS & DETAILS** BUILDING SECTIONS AND DETAILS BUILDING DETAILS YARD DETAILS FOUNDATION PLAN, ROOF FRAMING PLAN, STRUCTURAL DETAILS FOUNDATION AND FRAMING DETAILS STRUCTURAL NOTES ELECTRICAL PLANS PANE SCHEDULE AND DETAILS DISPENSER AND LEAK DETECTION WIRING PLUMBING PLANS CANOPY CONSTRUCTION & FOUNDATION PLANS CANOPY EXTERIOR ELEVATIONS & SIGNAGE CANOPY ELECTRICAL PLANS & DETAILS TANK AND PIPING FUELING LAYOUTS - LCX TANK AND PIPING MATERIALS LIST (1 OF 2) - LCX TANK AND PIPING MATERIALS LIST (2 OF 2) - LCX 20,000 GALLON TANK PLAN AND SECTION INSTALLATION DETAILS - LCX 10,000/8,000 GALLON TANK PLAN AND SECTION INSTALLATION DETAILS - LCX TANK SLAB, ANCHORING AND MISCELLANEOUS INSTALLATION DETAILS TANK TURBINE/FILL SUMP & STATIC GROUNDING INSTALLATION DETAILS TANK TURBINE SUMP & MISCELLANEOUS INSTALLATION DETAILS (ALL CONFIGURATIONS) TANK FILL SUMP & FITTING INSTALLATION DETAILS DISPENSER & PIPING INSTALLATION DETAILS (WAYNE OVATION 3+0) DISPENSER & PIPING INSTALLATION DETAILS (WAYNE OVATION 3+1)

SHEET INDEX

37704 Hills Tech Drive

Farmington Hills, MI 48331 734.367.4445 Telephone

Corporate Office:

4925 Forest Avenue Downers Grove, IL 60515

SAFETY - INTEGRITY - SUSTAINABIL

NO. DATE DESCRIPTION 1 | 08.10.2017 | SITE PLAN/CONDITIONAL USE

CONSULTANT

TIMOTHY B . & KRATZ **PORTAGE**

CUSTOMER

Pick 'n Save

PROJECT DESCRIPTION

534-00390 **RETAIL FUEL CENTER**

PROJECT LOCATION

1750 HWY. 51 WEST STOUGHTON, WI 53589

(DANE COUNTY)

SHEET TITLE

COVER SHEET

SHEET MANAGEMENT G0.01.dwg ROJECT MANAGER: T. KRATZ (NOT PUBLISHED: ALL RIGHTS RESERVED.)

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SHEET NUMBER

G0.01

GENERAL NOTES:

- l. IT IS THE RESPONSIBILITY OF THE GENERAL CONTRACTOR TO KNOW ALL OBSERVABLE CONDITIONS AND TO CONFORM TO ALL APPLICABLE CODES. THE GENERAL CONTRACTOR SHALL INFORM THE OWNER'S REPRESENTATIVE OF ANY NECESSARY OR APPROPRIATE QUESTIONS OR CLARIFICATIONS. THE GENERAL CONTRACTOR SHALL INCORPORATE ALL APPLICABLE FEDERAL, STATE, AND LOCAL CODES AND STANDARDS, INCLUDING FEDERAL ADA REQUIREMENTS.
- 2. THE DRAWINGS AND PROJECT MANUAL (INCLUDING ASSOCIATED STUDIES, DRAWINGS, SHOP DRAWINGS AND SIMILAR INSTRUMENTS AS APPLICABLE) CONSTITUTE THE GUIDELINES FOR THE PROJECT AND SHALL BE USED IN CONJUNCTION WITH THE AFOREMENTIONED ENTIRE BODY OF PROJECT INFORMATION. IT IS THE RESPONSIBILITY OF THE GENERAL CONTRACTOR TO PROVIDE COMPLETE INFORMATION TO ALL JURISDICTIONAL AUTHORITIES, SUBCONTRACTORS, ALLIED CONSULTANTS, HIRES, AND ASSIGNS.
- 3. ALL CONSTRUCTION SHALL COMPLY WITH THE DRAWINGS, PROJECT MANUAL, CODES AND STANDARDS OF THE JURISDICTIONAL AUTHORITY OR AUTHORITIES. ALL CONSTRUCTION SHALL BE PERFORMED IN ACCORDANCE WITH ALL APPLICABLE OSHA, FEDERAL, STATE AND LOCAL REGULATIONS. IN CASE OF DISCREPANCIES, THE MORE STRINGENT REQUIREMENT SHALL APPLY.
- 4. THE GENERAL CONTRACTOR PERFORMING THE WORK SHALL MAINTAIN A GENERAL "A" LICENSE WITH HAZ MAT CERTIFICATION FROM THE CONTRACTOR'S STATE LICENSE BOARD AND/OR OTHER JURISDICTIONAL AUTHORITY.
- 5. THE GENERAL CONTRACTOR SHALL IMMEDIATELY NOTIFY THE OWNER'S REPRESENTATIVE OF ANY DISCREPANCIES FOUND DURING THE INVESTIGATION OF EXISTING UTILITIES AND TOPOGRAPHY AND/OR DURING THE CONSTRUCTION PHASE.
- 6. THE GENERAL CONTRACTOR IS RESPONSIBLE FOR ALL PERMITS, PERMIT FEES, LICENSES AND LICENSE FEES. THE GENERAL CONTRACTOR SHALL OBTAIN ALL NECESSARY CONSTRUCTION PERMITS REQUIRED TO PERFORM ALL REQUIRED WORK. THE CONTRACTOR SHALL POST ALL BONDS, PAY ALL FEES, PROVIDE PROOF OF INSURANCE AND PROVIDE ALL TRAFFIC CONTROL NECESSARY FOR THIS
- . WORK SHALL CONFORM TO THE REQUIREMENTS OF THE GOVERNING AGENCY OR AGENCIES HAVING JURISDICTION. GRADING, PAVING, AND MATERIALS SHALL COMPLY WITH THE JURISDICTIONAL ROADWAY AUTHORITY OR AUTHORITIES (E.G., DEPARTMENT OF TRANSPORTATION) STANDARD SPECIFICATIONS FOR CONSTRUCTION AS WELL AS PROJECT SPECIFICATIONS AND DRAWINGS. IN CASE OF DISCREPANCIES BETWEEN REQUIREMENTS, ATTAIN CLARIFICATION FROM THE OWNER'S REPRESENTATIVE.
- 8. THE GENERAL CONTRACTOR SHALL ENSURE ALL SITE INSPECTIONS REQUIRED BY CITY AND/OR STATE AGENCIES, AND/OR OTHER JURISDICTIONAL AUTHORITY ARE TO BE SCHEDULED A MINIMUM OF FIVE WORKING DAYS IN ADVANCE OF REQUESTED INSPECTION DATE.
- 9. THE GENERAL CONTRACTOR SHALL VERIFY ALL SITE CONDITIONS IN THE FIELD AND CONTACT THE OWNER'S REPRESENTATIVE IF THERE ARE ANY QUESTIONS OR CONFLICTS REGARDING THE DRAWINGS, PROJECT MANUAL AND/OR FIELD CONDITIONS SO THAT APPROPRIATE ADJUSTMENTS AND/OR REVISIONS CAN BE MADE PRIOR TO CONSTRUCTION. ANY CONFLICTS BETWEEN THE DRAWINGS AND PROJECT MANUAL SHALL BE IDENTIFIED BY THE GENERAL CONTRACTOR AND CONFIRMED WITH THE OWNER'S REPRESENTATIVE PRIOR TO BIDDING.
- 10. MATERIAL TESTING SHALL BE SUPPLIED BY THE OWNER'S REPRESENTATIVE. THE GENERAL CONTRACTOR SHALL COORDINATE WITH TESTING FIRM. ALL RE-TESTING IS THE RESPONSIBILITY OF THE GENERAL CONTRACTOR.
- 11. SOIL SAMPLES MAY BE REQUIRED TO BE TAKEN FOR TESTING AT THE DIRECTION OF HAZ MAT, OTHER JURISDICTIONAL AUTHORITY, OR THE OWNER'S REPRESENTATIVE.
- 12. THE GENERAL CONTRACTOR SHALL MAINTAIN A CLEAN WORK AREA. TRASH AND WASTE MATERIALS SHALL BE COLLECTED AT A SAFE POINT, AWAY FROM FLAMES OR OTHER FIRE SOURCES. THE GENERAL CONTRACTOR SHALL PREVENT ANY LEAKS OR DRIPS OF HYDRAULIC FLUID, MOTOR OIL, MOTOR FUELS, SOLVENTS, AND OTHER HYDROCARBONS FROM CONTAMINATING THE GROUND. SUCH SPILLS SHALL BE IMMEDIATELY COVERED WITH AN OIL ABSORBING MEDIUM (E.G. "OIL DRY") AND REMOVED FROM THE SITE IN A LEGAL AND ENVIRONMENTALLY SOUND MANNER. TRASH SHALL BE PROPERLY DISPOSED OF DAILY, UNLESS A COVERED DUMPSTER IS PROVIDED AND ITS LOCATION APPROVED BY THE OWNER'S REPRESENTATIVE.
- 13. THE GENERAL CONTRACTOR IS RESPONSIBLE FOR THE REMOVAL AND DISPOSAL OF ALL RUBBISH, TRASH, DEBRIS AND ORGANIC MATERIAL IN A LAWFUL MANNER.
- 14. PROVIDE ADEQUATE BARRICADES AT DRIVES, ENTRANCES, EXCAVATIONS, OTHER OPENINGS, AND HAZARDOUS AREAS TO KEEP OUT UNAUTHORIZED PERSONS. FOR PUBLIC SAFETY, AND TRAFFIC CONTROL. SAFETY PROVISIONS OF APPLICABLE LAWS SHALL BE OBSERVED AT ALL TIMES. BARRICADES LEFT IN PLACE AT NIGHT SHALL BE LIGHTED.
- 15. THE GENERAL CONTRACTOR SHALL BE RESPONSIBLE FOR SHORING AND FOR DEWATERING TO ACCOMPLISH ALL WORK INDICATED ON PLANS AND TO PERFORM REQUIRED COMPACTION OPERATIONS. DEWATERING SHALL NOT DISCHARGE TO ANY SANITARY SEWER SYSTEM OR BE PUMPED ONTO ANY PUBLIC ROADWAY.
- 16. PROMPTLY REMOVE ALL DEMOLITIONS, PROJECT DISCARDS, RUBBISH, AND DEBRIS FROM THE LIMITS OF THE OWNER'S PROPERTY AND/OR EFFECTIVE PROJECT LIMITS, AND DISPOSE IN A LEGAL
- 17. ALL EQUIPMENT TO BE INSTALLED SHALL BE UL APPROVED.
- 18. THE GENERAL CONTRACTOR SHALL PROVIDE A TRAFFIC SEQUENCING AND SCHEDULING PLAN AT THE ON-SITE PRE-CONSTRUCTION MEETING WITH THE OWNER'S REPRESENTATIVES AND APPLICABLE LANDLORD'S REPRESENTATIVE(S).
- 19. THE GENERAL CONTRACTOR'S MANNER AND METHOD OF INGRESS AND EGRESS WITH RESPECT TO THE PROJECT AREA SHALL IN NO WAY PROHIBIT OR DISTURB NORMAL PEDESTRIAN OR VEHICULAR TRAFFIC IN THE VICINITY AND IS SUBJECT TO REGULATION AND WRITTEN APPROVAL OF AFFECTED OWNER(S), JURISDICTIONAL AUTHORITY, AND/OR AUTHORITIES, AS APPLICABLE.
- ALL CONSTRUCTION SHALL BE CONDUCTED TO CAUSE MINIMAL INTERFERENCE WITH STREETS, DRIVES OR WALKS. THE GENERAL CONTRACTOR IS RESPONSIBLE FOR MAINTENANCE OF TRAFFIC AND SHALL NOT CAUSE THE CLOSURE OR OBSTRUCTION OF STREETS, DRIVES, WALKS OR USER FACILITIES WITHOUT PERMISSION FROM THE OWNER'S REPRESENTATIVE.
- 21. THE GENERAL CONTRACTOR SHALL PHASE CONSTRUCTION IN SUCH A WAY AS TO MAINTAIN AN ACCESS ROUTE FROM AN ENTRANCE DRIVE TO TRUCK DOCKS AND/OR LOADING AREA(S) AT ALL
- 22. CONTRACTOR SHALL KEEP EXISTING STREETS, ROADS AND DRIVES CLEAR OF DIRT, DEBRIS AND EQUIPMENT.
- 23. THE GENERAL CONTRACTOR SHALL OBTAIN APPROVAL FROM THE OWNER'S REPRESENTATIVE FOR PARKING AND STORAGE OF EQUIPMENT. THIS AREA, AS WELL AS THE JOB SITE, SHALL BE ENCLOSED IN CHAIN LINK FENCING. A TRAFFIC LANE SHALL BE DESIGNATED FOR INGRESS AND EGRESS FROM THE WORK AREA. IF REQUIRED, FLAG MEN SHALL BE PROVIDED TO PROVIDE FOR SAFE AND EFFICIENT MOVEMENT OF VEHICLES. NO CHANGES TO THE WORK AREA OR TO THE AGREED TRAFFIC PATTERN SHALL BE MADE WITHOUT PRIOR APPROVAL OF THE OWNER'S REPRESENTATIVE; THE OWNER'S REPRESENTATIVE WILL SECURE APPROVAL FOR SUCH CHANGES, IF APPLICABLE.
- 24. NO EQUIPMENT OR MATERIAL STORAGE IS PERMITTED WITHIN THE ROAD RIGHT-OF-WAY.
- 25. FOR THE DURATION OF CONSTRUCTION OPERATIONS, EMPLOYEE(S) WILL PARK IN A LOCATION DESIGNATED BY THE OWNER'S REPRESENTATIVE.
- 26. RESTORE ALL STREET SURFACES, DRIVEWAYS, CULVERTS, ROADSIDE DRAINAGE DITCHES, AND OTHER PUBLIC OR PRIVATE STRUCTURES THAT ARE DISTURBED OR DAMAGED AS A RESULT ON CONSTRUCTION ACTIVITIES TO A CONDITION EQUAL TO OR BETTER THAN EXISTING CONDITIONS AND TO THE SATISFACTION OF AFFECTED OWNER(S), JURISDICTIONAL AUTHORITY, AND/OR AUTHORITIES, AS APPLICABLE.
- 27. PROTECT EXISTING TREES TO REMAIN WITH TEMPORARY FENCING PLACED AT THE DRIP LINE. NO GROUND DISTURBANCE OR STORAGE OF MATERIAL SHALL OCCUR WITHIN THE DRIP LINE LIMITS, UNLESS HEREON EXPRESSLY INDICATED OTHERWISE.
- 28. WRITTEN DIMENSIONS SHALL PREVAIL. NO DIMENSION MAY BE SCALED. REFER ANY UNCLEAR ITEMS TO THE OWNER'S REPRESENTATIVE FOR INTERPRETATION.

- 29. THE GENERAL CONTRACTOR SHALL BE RESPONSIBLE FOR VERIFYING ALL PROPOSED DIMENSIONS FOR BUILDINGS, WALLS, CONCRETE SLABS, UTILITY SERVICE POINT CONNECTIONS, ETC., AND SHALL NOTIFY THE OWNER'S REPRESENTATIVE OF ANY CONFLICTS OR DISCREPANCIES PRIOR TO CONSTRUCTION.
- 30. COORDINATES AND/OR DIMENSIONS SHOWN ON THESE DRAWINGS ARE TO BACK OF CURB, OUTSIDE FACE OF BUILDING FOUNDATIONS, EDGE OF PAVEMENT, OR CENTER OF STRUCTURE OR SIGN UNLESS NOTED OTHERWISE.
- 31. ANY BEARINGS USED HEREON ARE FOR THE PURPOSE OF ANGULAR MEASUREMENT ONLY AND ARE NOT NECESSARILY REFERENCED TO TRUE OR MAGNETIC NORTH.
- 32. UNDERGROUND UTILITIES MUST BE MARKED, AS REQUIRED BY PUBLIC ACT 53 OF 1974. TELEPHONE THE REGIONAL UTILITY LOCATOR/ONE-CALL SYSTEM OFFICE BEFORE ANY DIGGING.
- 33. THE GENERAL CONTRACTOR AT ALL TIMES SHALL ABIDE BY ALL OSHA, FEDERAL, STATE AND LOCAL REGULATIONS WHEN OPERATING CRANES, BOOMS, HOISTS, ETC. IN CLOSE PROXIMITY TO OVERHEAD LINES. IF THE GENERAL CONTRACTOR MUST OPERATE EQUIPMENT CLOSE TO UNDERGROUND AND/OR OVERHEAD ELECTRIC LINES, CONTACT THE AFFECTED UTILITY COMPANY AND MAKE ARRANGEMENTS FOR PROPER SAFEGUARDS, PRIOR TO OPERATION.
- 34. THE GENERAL CONTRACTOR SHALL, AT HIS OR HER EXPENSE, RESTORE ANY AND ALL STRUCTURES, PIPE, UTILITY, PAVEMENT, CURB, SIDEWALK, LANDSCAPED AREA, ETC. DISTURBED WITHIN THE SITE AND/OR ADJOINING PROPERTIES DURING DEMOLITION OR CONSTRUCTION. SUCH FACILITIES SHALL BE RESTORED TO THEIR ORIGINAL CONDITION OR BETTER, TO THE SATISFACTION OF THE AFFECTED OWNER(S).
- 35. THE GENERAL CONTRACTOR IS RESPONSIBLE FOR CONFIRMING THE HORIZONTAL AND VERTICAL LOCATION OF ALL EXISTING UTILITIES PRIOR TO ANY CONSTRUCTION.
- 36. IN ALL CASES THE LOCATION OF EXISTING UTILITIES SHOWN ON THESE PLANS IS ASSUMED TO BE APPROXIMATE. LOCATIONS ARE BASED ON THE BEST AVAILABLE REFERENCE PLANS AND AN ACTUAL FIELD SURVEY OF VISIBLE STRUCTURES. CONTACT THE REGIONAL UTILITY LOCATOR/ONE-CALL SYSTEM OFFICE BEFORE DIGGING.
- 37. THE GENERAL CONTRACTOR SHALL NOT INTERRUPT EXISTING UTILITIES AND/OR SERVICING FACILITIES OCCUPIED AND USED BY THE OWNER, LANDLORD, OR OTHERS DURING OCCUPIED HOURS EXCEPT WHEN SUCH INTERRUPTIONS HAVE BEEN AUTHORIZED IN WRITING BY THE AFFECTED OWNER, LANDLORD, JURISDICTIONAL AUTHORITY, AND/OR UTILITY COMPANY. INTERRUPTIONS SHALL OCCUR ONLY AFTER ACCEPTABLE TEMPORARY OR PERMANENT SERVICE HAS BEEN PROVIDED.
- 38. ELECTRICAL WORK IN OR AFFECTING THE MAIN STORE TO OCCUR AFTER BUSINESS HOURS AND AFTER STORE EMPLOYEES HAVE LEFT THE BUILDING.
- 39. THE CONTRACTOR SHALL MAINTAIN, AT THE JOB SITE, A COMPLETE SET OF CONSTRUCTION DOCUMENTS AND SPECIFICATIONS AND MAKE THEM AVAILABLE TO THE OWNER'S REPRESENTATIVE, SUBCONTRACTORS, AND/OR ALLIED CONSULTANTS THROUGHOUT THE CONSTRUCTION PROCESS.
- 40. THE GENERAL CONTRACTOR IS RESPONSIBLE FOR THE TIMELY COMPLETION OF ALL PHASES OF CONSTRUCTION. CONSTRUCTION PROJECT TO BE COMPLETED IN ACCORDANCE WITH ALL DRAWINGS AND PROJECT MANUAL, AND TURNED OVER TO THE OWNER'S REPRESENTATIVE IN FULLY OPERATIONAL CONDITION.
- 41. UPON COMPLETION OF THE WORK, THERE SHALL BE A FINAL INSPECTION OF THE PROJECT BY THE OWNER'S REPRESENTATIVE. ALL EQUIPMENT SHALL BE TESTED UNDER NORMAL OPERATING CONDITIONS. THE GENERAL CONTRACTOR SHALL HAVE AN ELECTRICIAN AVAILABLE DURING THE OPENING TO IMPLEMENT ANY APPROPRIATE OR REQUIRED ADJUSTMENTS TO THE EQUIPMENT.
- 42. AFTER ALL WORK HAS BEEN COMPLETED AND THE PROJECT HAS BEEN TESTED AND ACCEPTED, THE GENERAL CONTRACTOR SHALL SWEEP THE ENTIRE WORK AREA CLEAN AND REMOVE ALL DIRT, MUD, TRASH, WASTE MATERIAL, CONSTRUCTION EQUIPMENT, AND VEHICLES. DAMAGED PARKING STRIPES OR STAINED PAVEMENT SHALL BE REFINISHED TO ITS ORIGINAL CONDITION BY THE GENERAL CONTRACTOR.
- 43. SPECIAL CARE SHALL BE TAKEN DURING ALL TRENCHING OPERATIONS. SHEETING AND BRACING, CRIBBING, ETC. MUST BE INSTALLED AS NECESSARY OR APPROPRIATE TO PROVIDE MAXIMUM SAFETY TO THE GENERAL CONTRACTOR'S WORKERS, AND SHALL BE IN FULL COMPLIANCE WITH OSHA REGULATIONS.
- 44. SAWCUT AND REMOVE EXISTING ASPHALT PAVEMENT AS NEEDED TO INSTALL NEW CONCRETE CURBING, WALKS, UNDERGROUND UTILITIES AND/OR NEW BUILDING(S) OR STRUCTURE(S). SAWCUTS SHALL BE MADE A MINIMUM OF 1' BEYOND THE ACTUAL NEW CURB OR WALK LIMITS.
- 45. REMOVE AND REPLACE EXISTING PAVEMENT AS NEEDED TO MATCH EXISTING AND PROPOSED GRADES.
- 46. PRIOR TO PROCEEDING FURTHER WITH THE AFFECTED WORK, THE GENERAL CONTRACTOR SHALL NOTIFY THE OWNER'S REPRESENTATIVE OF ANY DISCREPANCY REGARDING THE PROPOSED WORK OR UNFORESEEN CONDITIONS.
- 47. ALL PAVEMENTS ASSOCIATED AGGREGATE MATERIALS AND WORK COMPLETED SHALL BE IN STRICT ACCORDANCE WITH THE STATE DOT OR OTHER JURISDICTIONAL AUTHORITY SPECIFICATIONS AND STANDARD DETAILS UNLESS OTHERWISE EXPRESSLY SPECIFIED IN THE DRAWINGS AND PROJECT MANUAL.
- 48. PIPE BOLLARDS SHALL BE INSTALLED IN TRAFFIC AND LOADING ARES AS REQUIRED TO PROTECT BUILDING CORNERS, RECEIVING AREAS, HYDRANTS, TRANSFORMERS, METERS, GENERATORS, COMPACTORS, STEPS AND RAILINGS AS NECESSARY. SEE DETAIL 9/C5.00.
- 49. WHENEVER REQUIRED OR APPROPRIATE, THE GENERAL CONTRACTOR SHALL SUBMIT SHOP DRAWINGS OF ALL PRODUCTS AND MATERIALS TO THE OWNER'S REPRESENTATIVE. ENGINEER AND JURISDICTIONAL AUTHORITY OR AUTHORITIES, AND SHALL ACQUIRE SHOP DRAWING APPROVAL PRIOR TO FABRICATION AND/OR DELIVERY TO THE SITE. ALLOW A MINIMUM OF 14 WORKING DAYS FOR REVIEW AND APPROVAL.
- 50. THE GENERAL CONTRACTOR SHALL REFERENCE ARCHITECTURAL PLANS FOR EXACT DIMENSIONS AND CONSTRUCTION DETAILS OF BUILDING(S), ROOF DRAINS, RAISED CONCRETE SIDEWALKS, RAMPS, STAIRWAYS, ETC.
- 51. TRAFFIC CONTROL SIGNS SHALL CONFORM TO THE STATE DOT AND/OR OTHER JURISDICTIONAL AUTHORITY STANDARDS, AND TO THE MOST CURRENT "MANUAL ON UNIFORM TRAFFIC CONTROL DEVICES".
- 52. FIRE LANES SHALL BE ESTABLISHED AND PROPERLY DESIGNATED IN ACCORDANCE WITH THE LOCAL MUNICIPALITY, FIRE DEPARTMENT AND OTHER JURISDICTIONAL AUTHORITY REQUIREMENTS.
- 53. IF APPLICABLE, THE GENERAL CONTRACTOR SHALL REMOVE ON-SITE CONFLICTING PAVEMENT MARKINGS IN A METHOD APPROVED BY THE OWNER'S REPRESENTATIVE, STATE DOT AND OTHER JURISDICTIONAL AUTHORITY. THE GENERAL CONTRACTOR SHALL EXERCISE CARE TO AVOID INSTALLATION OF CONFLICTING SIGNS AND MARKINGS.
- 54. AGGREGATE AND BITUMINOUS PAVEMENT MATERIALS AND INSTALLATION SHALL BE IN ACCORDANCE WITH STATE DOT AND/OR OTHER JURISDICTIONAL AUTHORITY STANDARDS. THE GENERAL CONTRACTOR SHALL SUBMIT AGGREGATE SIEVE ANALYSES AND JOB-MIX FORMULAS FOR AGGREGATE AND BITUMINOUS PAVEMENT TO THE OWNER'S REPRESENTATIVE FOR REVIEW AND APPROVAL AT LEAST 14 DAYS PRIOR TO PAVEMENT INSTALLATION.
- 55. ALTERNATIVE METHODS AND PRODUCTS OTHER THAN THOSE SPECIFIED IN THE DRAWINGS AND PROJECT MANUAL MAY BE USED IF REVIEWED AND APPROVED BY THE OWNER'S REPRESENTATIVE AND OTHER AFFECTED JURISDICTIONAL AUTHORITY PRIOR TO INSTALLATION.
- 56. THE GENERAL CONTRACTOR IS RESPONSIBLE FOR OBTAINING ALL NECESSARY CONSTRUCTION PLANS. SHOP DRAWINGS. LAYOUTS AND SURVEY INFORMATION, AND FOR EXECUTING ALL SURVEY FIELD WORK REQUIRED, TO PERFORM CONSTRUCTION IN ACCORDANCE WITH THE DRAWINGS AND PROJECT MANUAL.
- 57. THE OWNER'S REPRESENTATIVE RESERVES THE RIGHT TO MODIFY THE DETAILS

AND STANDARDS OF CONSTRUCTION FOR ALL PRIVATE FACILITIES FROM THOSE INDICATED IN THE DRAWINGS AND PROJECT MANUAL, PROVIDED THAT ANY ALTERNATE STANDARD COMPLIES WITH ALL JURISDICTIONAL AUTHORITY REQUIREMENTS, AND THAT THE GENERAL DESIGN INTENT OF THE PROJECT IS NOT COMPROMISED.

DEMOLITION NOTES:

- 1. SOIL EROSION AND SEDIMENTATION CONTROL MEASURES MUST BE IN PLACE PRIOR TO ANY SITE DEMOLITION, EXCAVATION OR GRADING.
- 2. PERFORM CLEARING, STRUCTURE REMOVAL, PAVEMENT REMOVAL AND APPLICABLE STOCKPILING IN ACCORDANCE WITH THE PROJECT DRAWINGS AND PROJECT MANUAL. THE GENERAL CONTRACTOR IS RESPONSIBLE FOR THE LAWFUL REMOVAL AND DISPOSAL OF ALL RUBBISH, TRASH, DEBRIS, ORGANIC MATERIAL, ETC.
- 3. NO ATTEMPT IS MADE TO STIPULATE EACH ITEM TO BE REMOVED AND/OR DEMOLISHED, EITHER ON THE DRAWINGS OR IN THE PROJECT MANUAL. THE CONTRACTOR MUST VISIT THE SITE TO ASSESS EXISTING PHYSICAL CONDITIONS, AS WELL AS REVIEW THE DRAWINGS, AND ULTIMATELY DETERMINE WORK NECESSARY TO ACCOMPLISH INTENDED RESULTS DESCRIBED BY THE PROJECT DRAWINGS AND PROJECT MANUAL.
- 4. COMPLETELY RESTORE ALL DISTURBED AREAS TO CONDITION EQUAL TO OR BETTER THAN EXISTING CONDITION AND TO THE SATISFACTION OF AFFECTED OWNER(S) AND/OR GOVERNING AUTHORITY. ALL COSTS FOR CLEAN-UP, RESTORATION WORK AND OTHER RESTORATION OPERATIONS SUCH AS, BUT NOT LIMITED TO, CONSTRUCTION SIGNAGE, STREET SWEEPING AND MAINTAINING EXISTING UTILITIES SHALL BE THE GENERAL CONTRACTOR'S RESPONSIBILITY. RESTORATION WORK SHALL BE PERFORMED WITHIN FIVE (5) WORKING DAYS AFTER COMPLETION OF FINAL GRADING.
- 5. WHERE EXISTING PAVEMENT IS TO BE PARTIALLY REMOVED, SAWCUT PAVEMENT TO FULL DEPTH TO PROVIDE A SMOOTH JOINT WITH PROPOSED PAVEMENT.
- 6. ALL DEMOLITION WORK SHALL CONFORM TO THE STANDARDS AND SPECIFICATIONS OF THE JURISDICTIONAL AUTHORITY.
- 7. IF APPROPRIATE, RETAIN SOIL SPOILS FROM CONSTRUCTION EXCAVATION AND STORE AT DESIGNATED LOCATION FOR RE-USE, IN ACCORDANCE WITH THE GEOTECHNICAL REPORT, PROJECT DRAWINGS, AND OWNER'S REPRESENTATIVE APPROVAL(S).

- 1. PROTECT AND MAINTAIN CROSSINGS WITH ANY AND ALL OTHER UTILITY LINES.
- 2. THE GENERAL CONTRACTOR IS RESPONSIBLE FOR CONTACTING THE JURISDICTIONAL AUTHORITY OR AUTHORITIES TO PROVIDE FEES AND SECURE PERMITS FOR STREET CUTS AND CONNECTIONS TO EXISTING UTILITIES.
- 3. THOROUGH COORDINATION WITH THE RESPECTIVE UTILITY COMPANIES SHALL BE PERFORMED BY THE GENERAL CONTRACTOR TO INSURE THAT ALL UTILITY COMPANY, AND OTHER JURISDICTIONAL AUTHORITY STANDARDS FOR MATERIALS AND CONSTRUCTION METHODS ARE
- 4. THE GENERAL CONTRACTOR IS SOLELY RESPONSIBLE FOR DETERMINING ACTUAL LOCATIONS AND ELEVATIONS OF ALL UTILITIES, INCLUDING SERVICES AND SERVICE LINES, PRIOR TO CONSTRUCTION.
- 5. THE GENERAL CONTRACTOR SHALL VISIT THE SITE AND VERIFY THE ELEVATION AND LOCATION OF ALL UTILITIES BY VARIOUS MEANS PRIOR TO BEGINNING ANY EXCAVATION. TEST PITS SHALL BE DUG AT ALL LOCATIONS WHERE SEWERS CROSS EXISTING UTILITIES AND THE HORIZONTAL AND VERTICAL LOCATIONS OF THE UTILITIES SHALL BE DETERMINED. THE GENERAL CONTRACTOR SHALL CONTACT THE OWNER'S REPRESENTATIVE IN THE EVENT OF ANY UNFORESEEN CONFLICTS BETWEEN EXISTING AND PROPOSED UTILITIES SO THAT AN APPROPRIATE MODIFICATION MAY BE
- 6. THE GENERAL CONTRACTOR SHALL ARRANGE FOR AND COORDINATE WITH THE RESPECTIVE UTILITY COMPANIES FOR SERVICE INSTALLATIONS AND CONNECTIONS AND MAIN SERVICE RELOCATIONS. THE GENERAL CONTRACTOR SHALL COORDINATE THE WORK TO BE PERFORMED BY THE VARIOUS UTILITY COMPANIES, PAY ALL FEES AND SECURE ALL PERMITS FOR CONNECTIONS, DISCONNECTIONS, RELOCATIONS, INSPECTIONS AND DEMOLITION AS NECESSARY OR APPROPRIATE
- 7. THE GENERAL CONTRACTOR SHALL MAINTAIN ALL FLOWS AND UTILITY CONNECTIONS TO EXISTING BUILDINGS, ETC. WITHOUT INTERRUPTION UNLESS/UNTIL AUTHORIZED TO DISCONNECT BY THE OWNER'S REPRESENTATIVE, OTHER AFFECTED OWNER(S), THE UTILITY COMPANIES AND JURISDICTIONAL AUTHORITIES. THE CONTRACTOR SHALL INSTALL AS NECESSARY TEMPORARY SITE LIGHTING, GAS, SANITARY, WATER, STORM, ELECTRIC, TELEPHONE AND CABLE SERVICES TO BUILDING(S) THAT ARE TO REMAIN OPERATIONAL.
- 8. THE GENERAL CONTRACTOR SHALL PROVIDE SLEEVES UNDER FOOTINGS AND/OR THROUGH FOUNDATIONS FOR UTILITY CONNECTIONS.
- 9. THE GENERAL CONTRACTOR SHALL PROVIDE ALL BENDS, FITTINGS, ADAPTERS, ETC. AS REQUIRED FOR PIPE CONNECTIONS TO BUILDING/CANOPY STUB-OUTS, INCLUDING ROOF/FOOTING DRAIN CONNECTIONS AND ROOF LEADERS, AND TO THE STORM DRAINAGE SYSTEM.
- 10. ALL UTILITY CONSTRUCTION IS SUBJECT TO INSPECTION PRIOR TO APPROVAL FOR BACKFILL, IN ACCORDANCE WITH THE UTILITY COMPANY OR COMPANIES, AND OTHER JURISDICTIONAL AUTHORITY REQUIREMENTS.
- 11. THE GENERAL CONTRACTOR SHALL RESTORE ANY STRUCTURE, PIPE, PAVEMENT, CURBS, SIDEWALKS, APPROPRIATE LANDSCAPE AREAS, ETC. DISTURBED DURING CONSTRUCTION TO THE ORIGINAL CONDITION OR BETTER.
- 12. PENDING THE GENERAL CONTRACTOR'S NOTIFICATION OF AND APPROVAL BY THE OWNER'S REPRESENTATIVE, UTILITY CONNECTION DESIGN AS REFLECTED IN THE PLANS AND PROJECT MANUAL MAY CHANGE SUBJECT TO UTILITY COMPANY AND JURISDICTIONAL AUTHORITY REVIEW.

BID NOTES:

- 1. THE GENERAL CONTRACTOR SHALL REFER TO GEOTECHNICAL ENGINEERING REPORT,
- 2. THE GENERAL CONTRACTOR SHALL VISIT THE SITE BEFORE BIDDING.
- 3. THE GENERAL CONTRACTOR IS RESPONSIBLE FOR CALCULATING ALL QUANTITIES.

NOTES TO GENERAL CONTRACTOR:

- 1. UNDERGROUND UTILITIES MUST BE MARKED, AS REQUIRED BY PUBLIC ACT 53 OF 1974. TELEPHONE THE REGIONAL UTILITY LOCATOR/ONE-CALL SYSTEM OFFICE A MINIMUM OF THREE (3) WORKING DAYS BEFORE ANY DIGGING.
- THE GENERAL CONTRACTOR IS RESPONSIBLE FOR CONFIRMING THE HORIZONTAL AND VERTICAL LOCATION OF ALL EXISTING UTILITIES PRIOR TO ANY CONSTRUCTION.
- 3. THE GENERAL CONTRACTOR IS RESPONSIBLE FOR CALCULATING ALL MATERIAL QUANTITIES.
- 4. THE CONTRACTOR SHALL INCLUDE THE BITUMINOUS AND CONCRETE PAVING SHOWN ON THE PLANS IN THEIR BASE BID.
- 5. THE CONTRACTOR SHALL PROVIDE THE UP-CHARGE, IF ANY, TO INSTALL CONCRETE PAVING INSTEAD OF BITUMINOUS PAVING. THIS PRICE SHALL ALSO INCLUDE THE COSTS TO PROTECT THE NEW CONCRETE PAVING FROM WINTER CONDITIONS.

DISCLAIMERS:

- 1. THIS SET OF DRAWINGS IS INTENDED AS A SET OF GUIDELINES FOR THE PROJECT AND ARE TO BE USED IN CONJUNCTION WITH THE PROJECT MANUAL AND/OR SUPPLEMENTAL DATA TO BE PROVIDED BY THE OWNER'S REPRESENTATIVE. THEY MUST BE READ TO INCORPORATE ALL APPLICABLE FEDERAL, STATE, AND LOCAL CODES.
- 2. EXISTING SITE INFORMATION HEREON IS PROVIDED BY THE OWNER, SURVEYOR, PLANS PREPARED BY OTHERS, AND/OR FIELD SURFACE EVIDENCE. ALL LOCATIONS ARE PRESUMED TO BE APPROXIMATE. THE PROJECT COLLABORATIVE, INC. ASSUMES NO LIABILITY FOR INFORMATION REPRESENTING EXISTING CONDITIONS HEREON. IT IS THE GENERAL CONTRACTOR RESPONSIBILITY TO THOROUGHLY REVIEW THESE DRAWINGS AND SUPPLEMENTAL OWNER PROVIDED DATA WITH ACTUAL SITE CONDITIONS. THE GENERAL CONTRACTOR SHALL NOTE ANY DISCREPANCIES IN THE DRAWINGS AND ACTUAL SITE CONDITIONS, WHETHER SHOWN ON THE PLANS OR NOT, WITH THE OWNER'S REPRESENTATIVE PRIOR TO BIDDING AND CONSTRUCTION.
- 3. THE DRAWINGS AND PROJECT MANUAL ASSUME THERE ARE NO UNUSUAL SOIL CONDITIONS, UNKNOWN UNDERGROUND STRUCTURES OR IMPEDIMENTS, WIND LOADS, AND/OR SIMILAR UNFORESEEN CIRCUMSTANCES. UNUSUAL CONDITIONS DETECTED BY THE GENERAL CONTRACTOR SHALL BE IMMEDIATELY REPORTED TO THE OWNER'S REPRESENTATIVE AND MAY REQUIRE SIGNIFICANT CHANGES TO THESE DRAWINGS.
- 4. THE DRAWINGS AND PROJECT MANUAL ARE AND SHALL REMAIN THE PROPERTY OF THE KROGER CO. REPRODUCTION OR ALTERATION WITHOUT THE EXPRESS WRITTEN PERMISSION OF THE KROGER CO. IS PROHIBITED. (NOT PUBLISHED: ALL RIGHTS RESERVED).

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SAFETY - INTEGRITY - SUSTAINABIL

		REVISIONS
NO.	DATE	DESCRIPTION
1	08.10.2017	SITE PLAN/CONDITIONAL USE

CONSULTANT

SEAL TIMOTHY B : KRATZ E-45202-6 PORTAGE

CUSTOMER

PROJECT DESCRIPTION

534-00390 **RETAIL FUEL CENTER**

PROJECT LOCATION

1750 HWY. 51 WEST STOUGHTON, WI 53589

(DANE COUNTY)

SHEET TITLE


GENERAL NOTES


SHEET MANAGEMENT G0.02.dwg ROJECT MANAGER:

SHEET NUMBER

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PARKING REQUIREMENTS:

REQUIRED PARKING 1 PER 300 SF GROSS GROSS BUILDING AREA ≈ 92,804 SF 309 SPACES REQUIRED

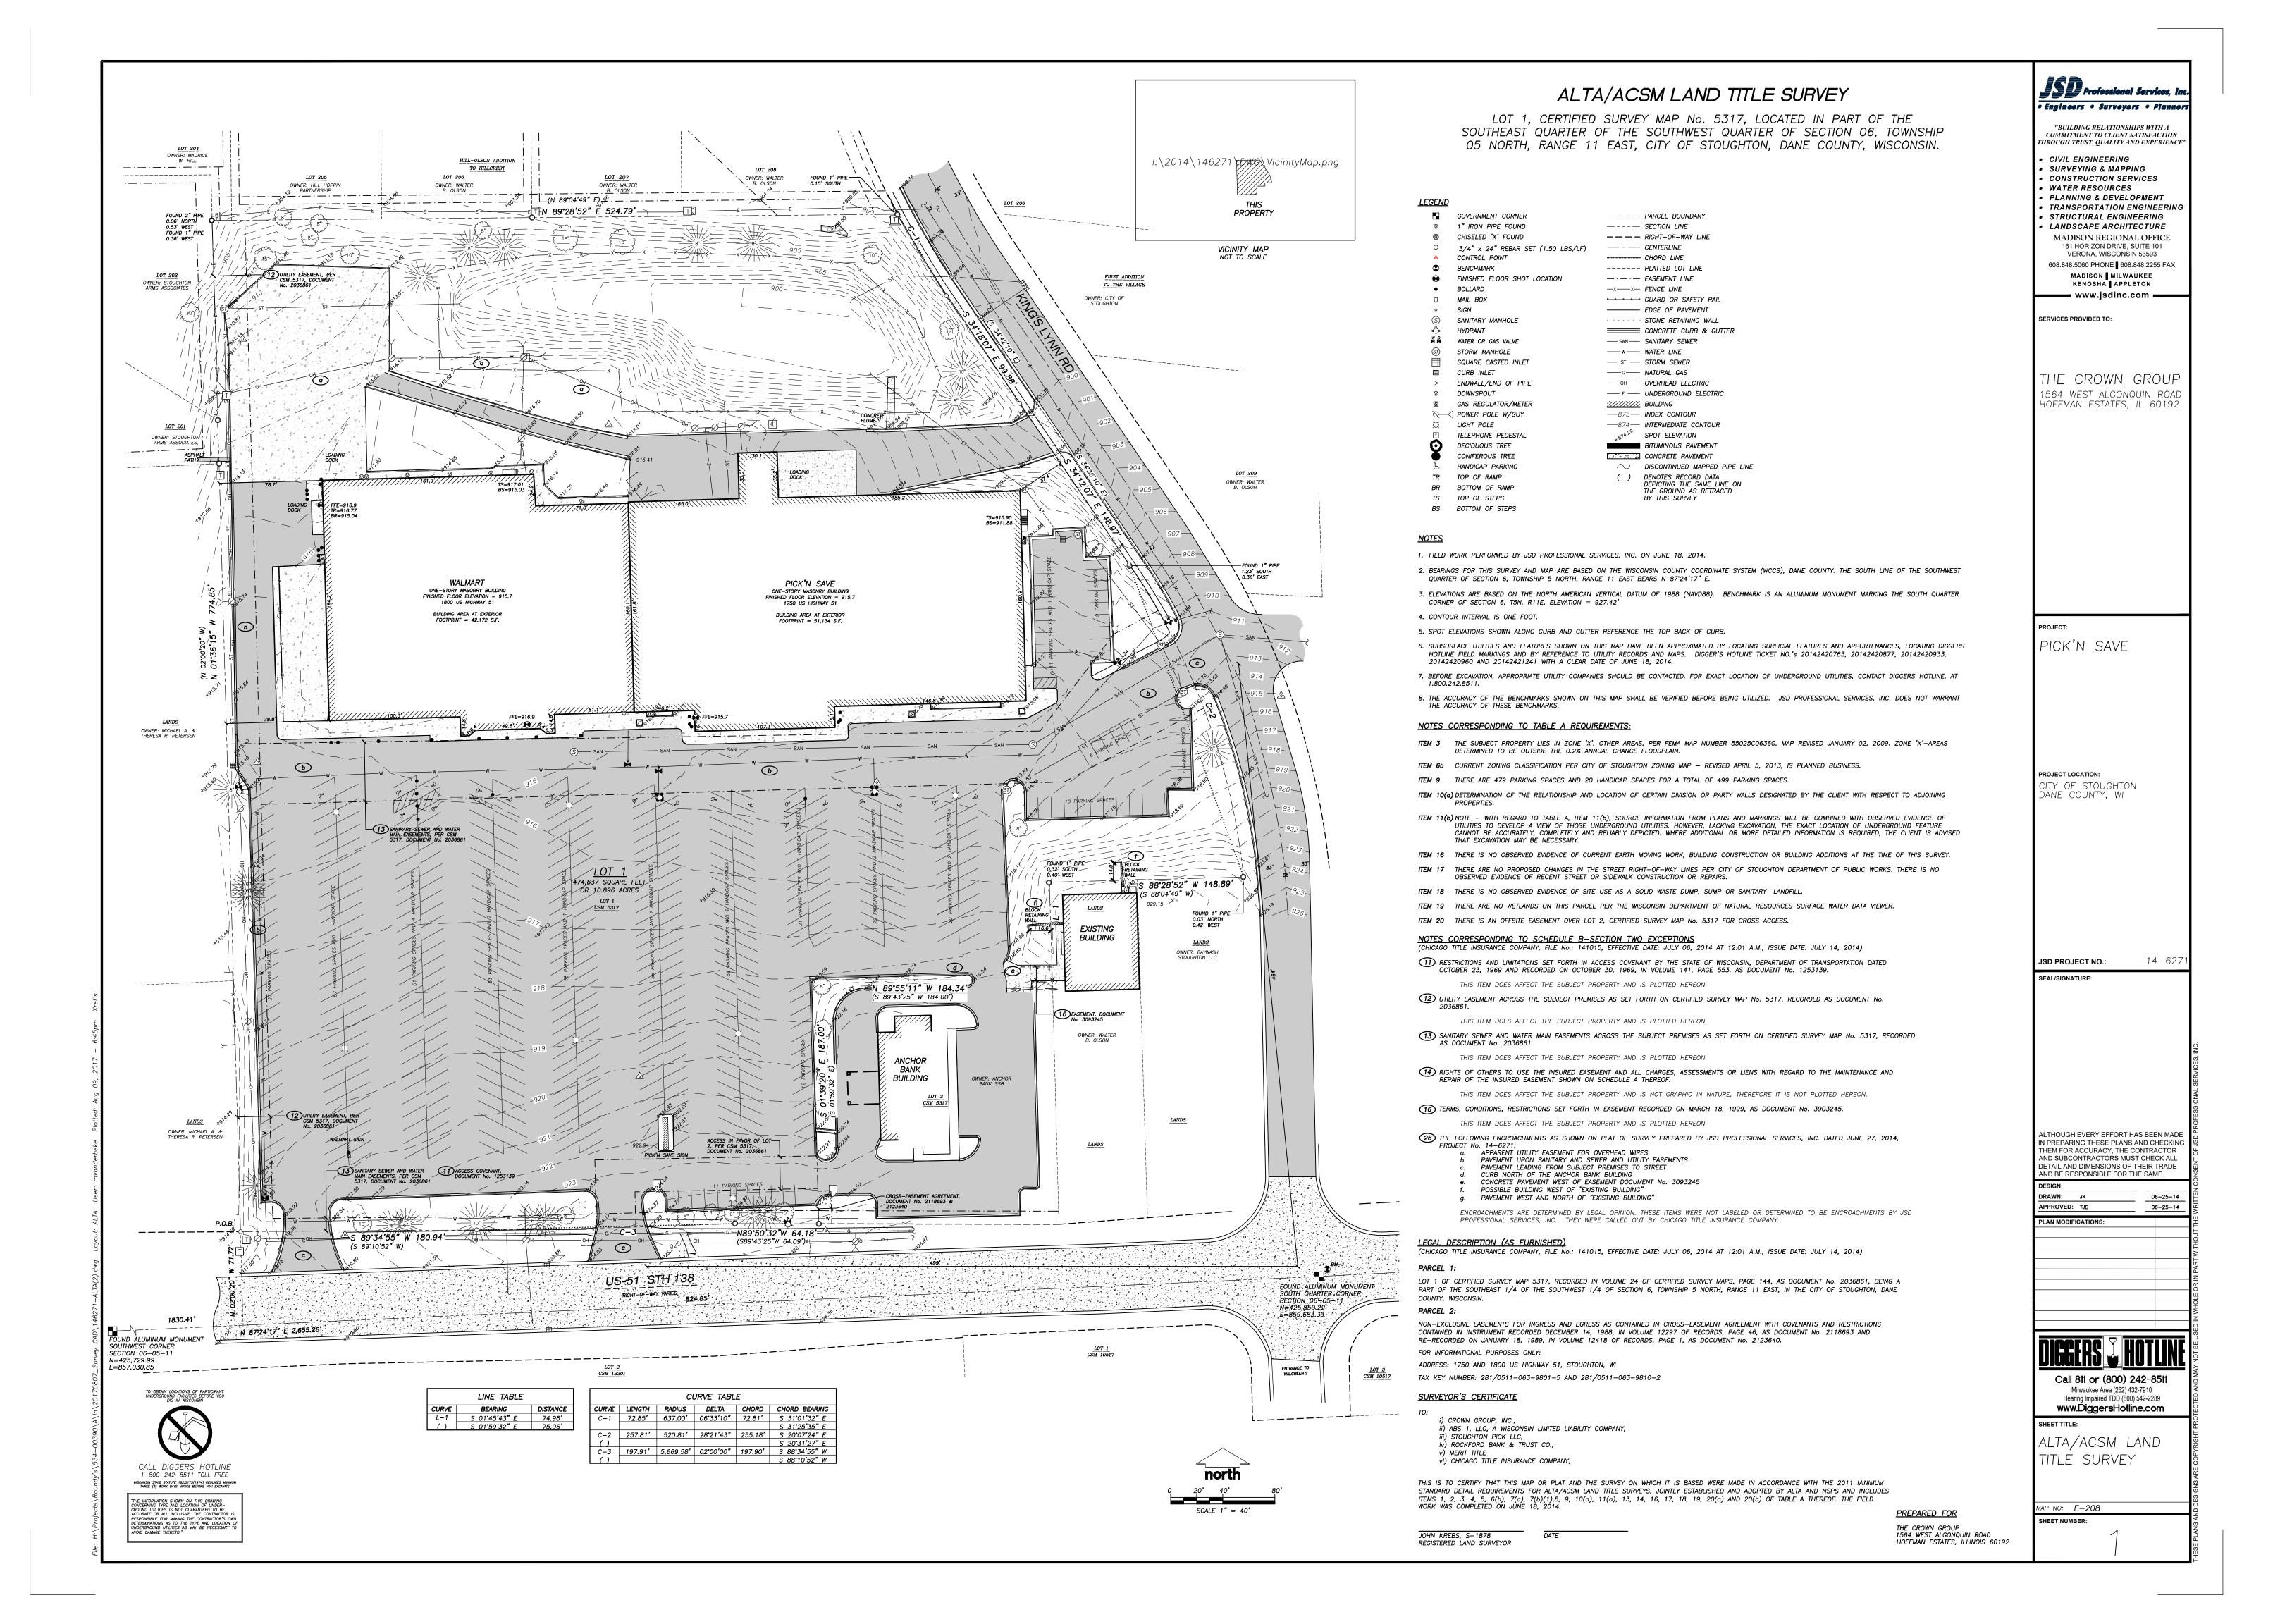PARKING SPACES PRIOR TO RENOVATIONS 481 SPACES + 20 HC SPACES = 501 SPACES

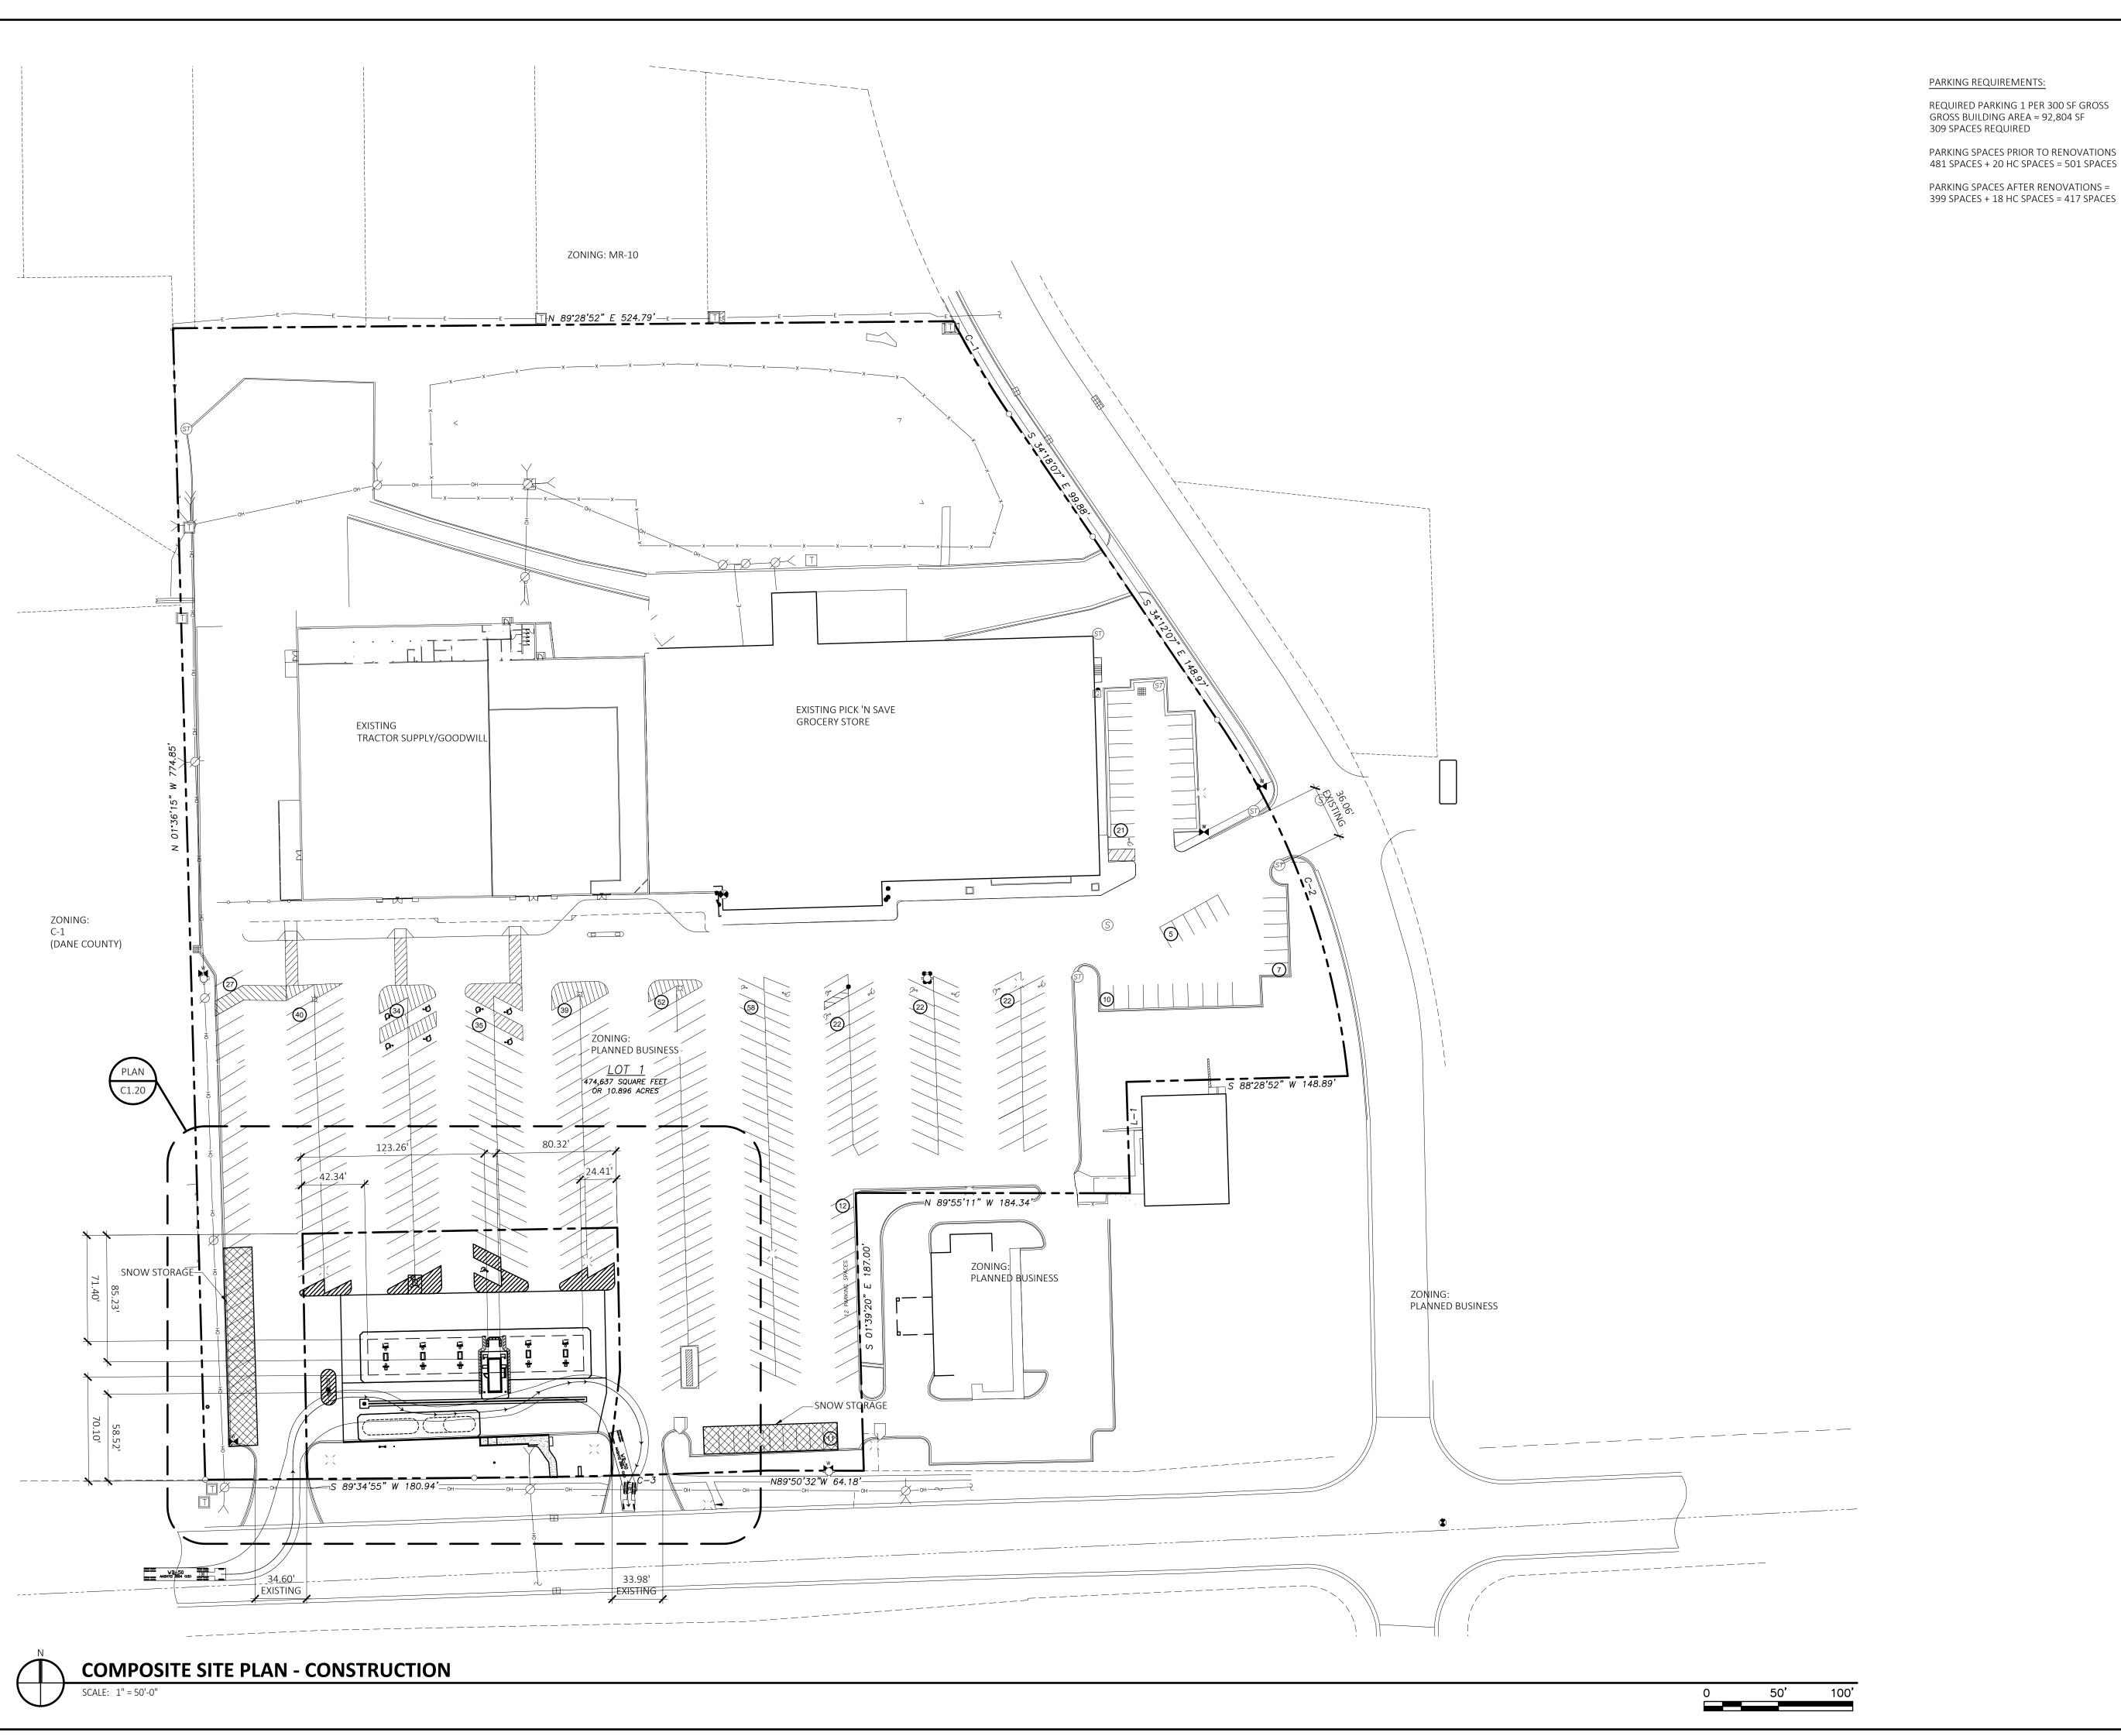PARKING SPACES AFTER RENOVATIONS =

MULTI-SITE SOLUTIONS

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REVISIONS NO. DATE DESCRIPTION 0 | 07.13.2017 CITY REVIEW 1 08.10.2017 SITE PLAN/CONDITIONAL USE

CONSULTANT

PORTAGE

CUSTOMER

PROJECT DESCRIPTION

534-00390 **RETAIL FUEL CENTER**

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(DANE COUNTY)


SHEET TITLE

COMPOSITE SITE PLAN CONSTRUCTION

C1.02.dwg

SHEET MANAGEMENT

SHEET NUMBER C1.02

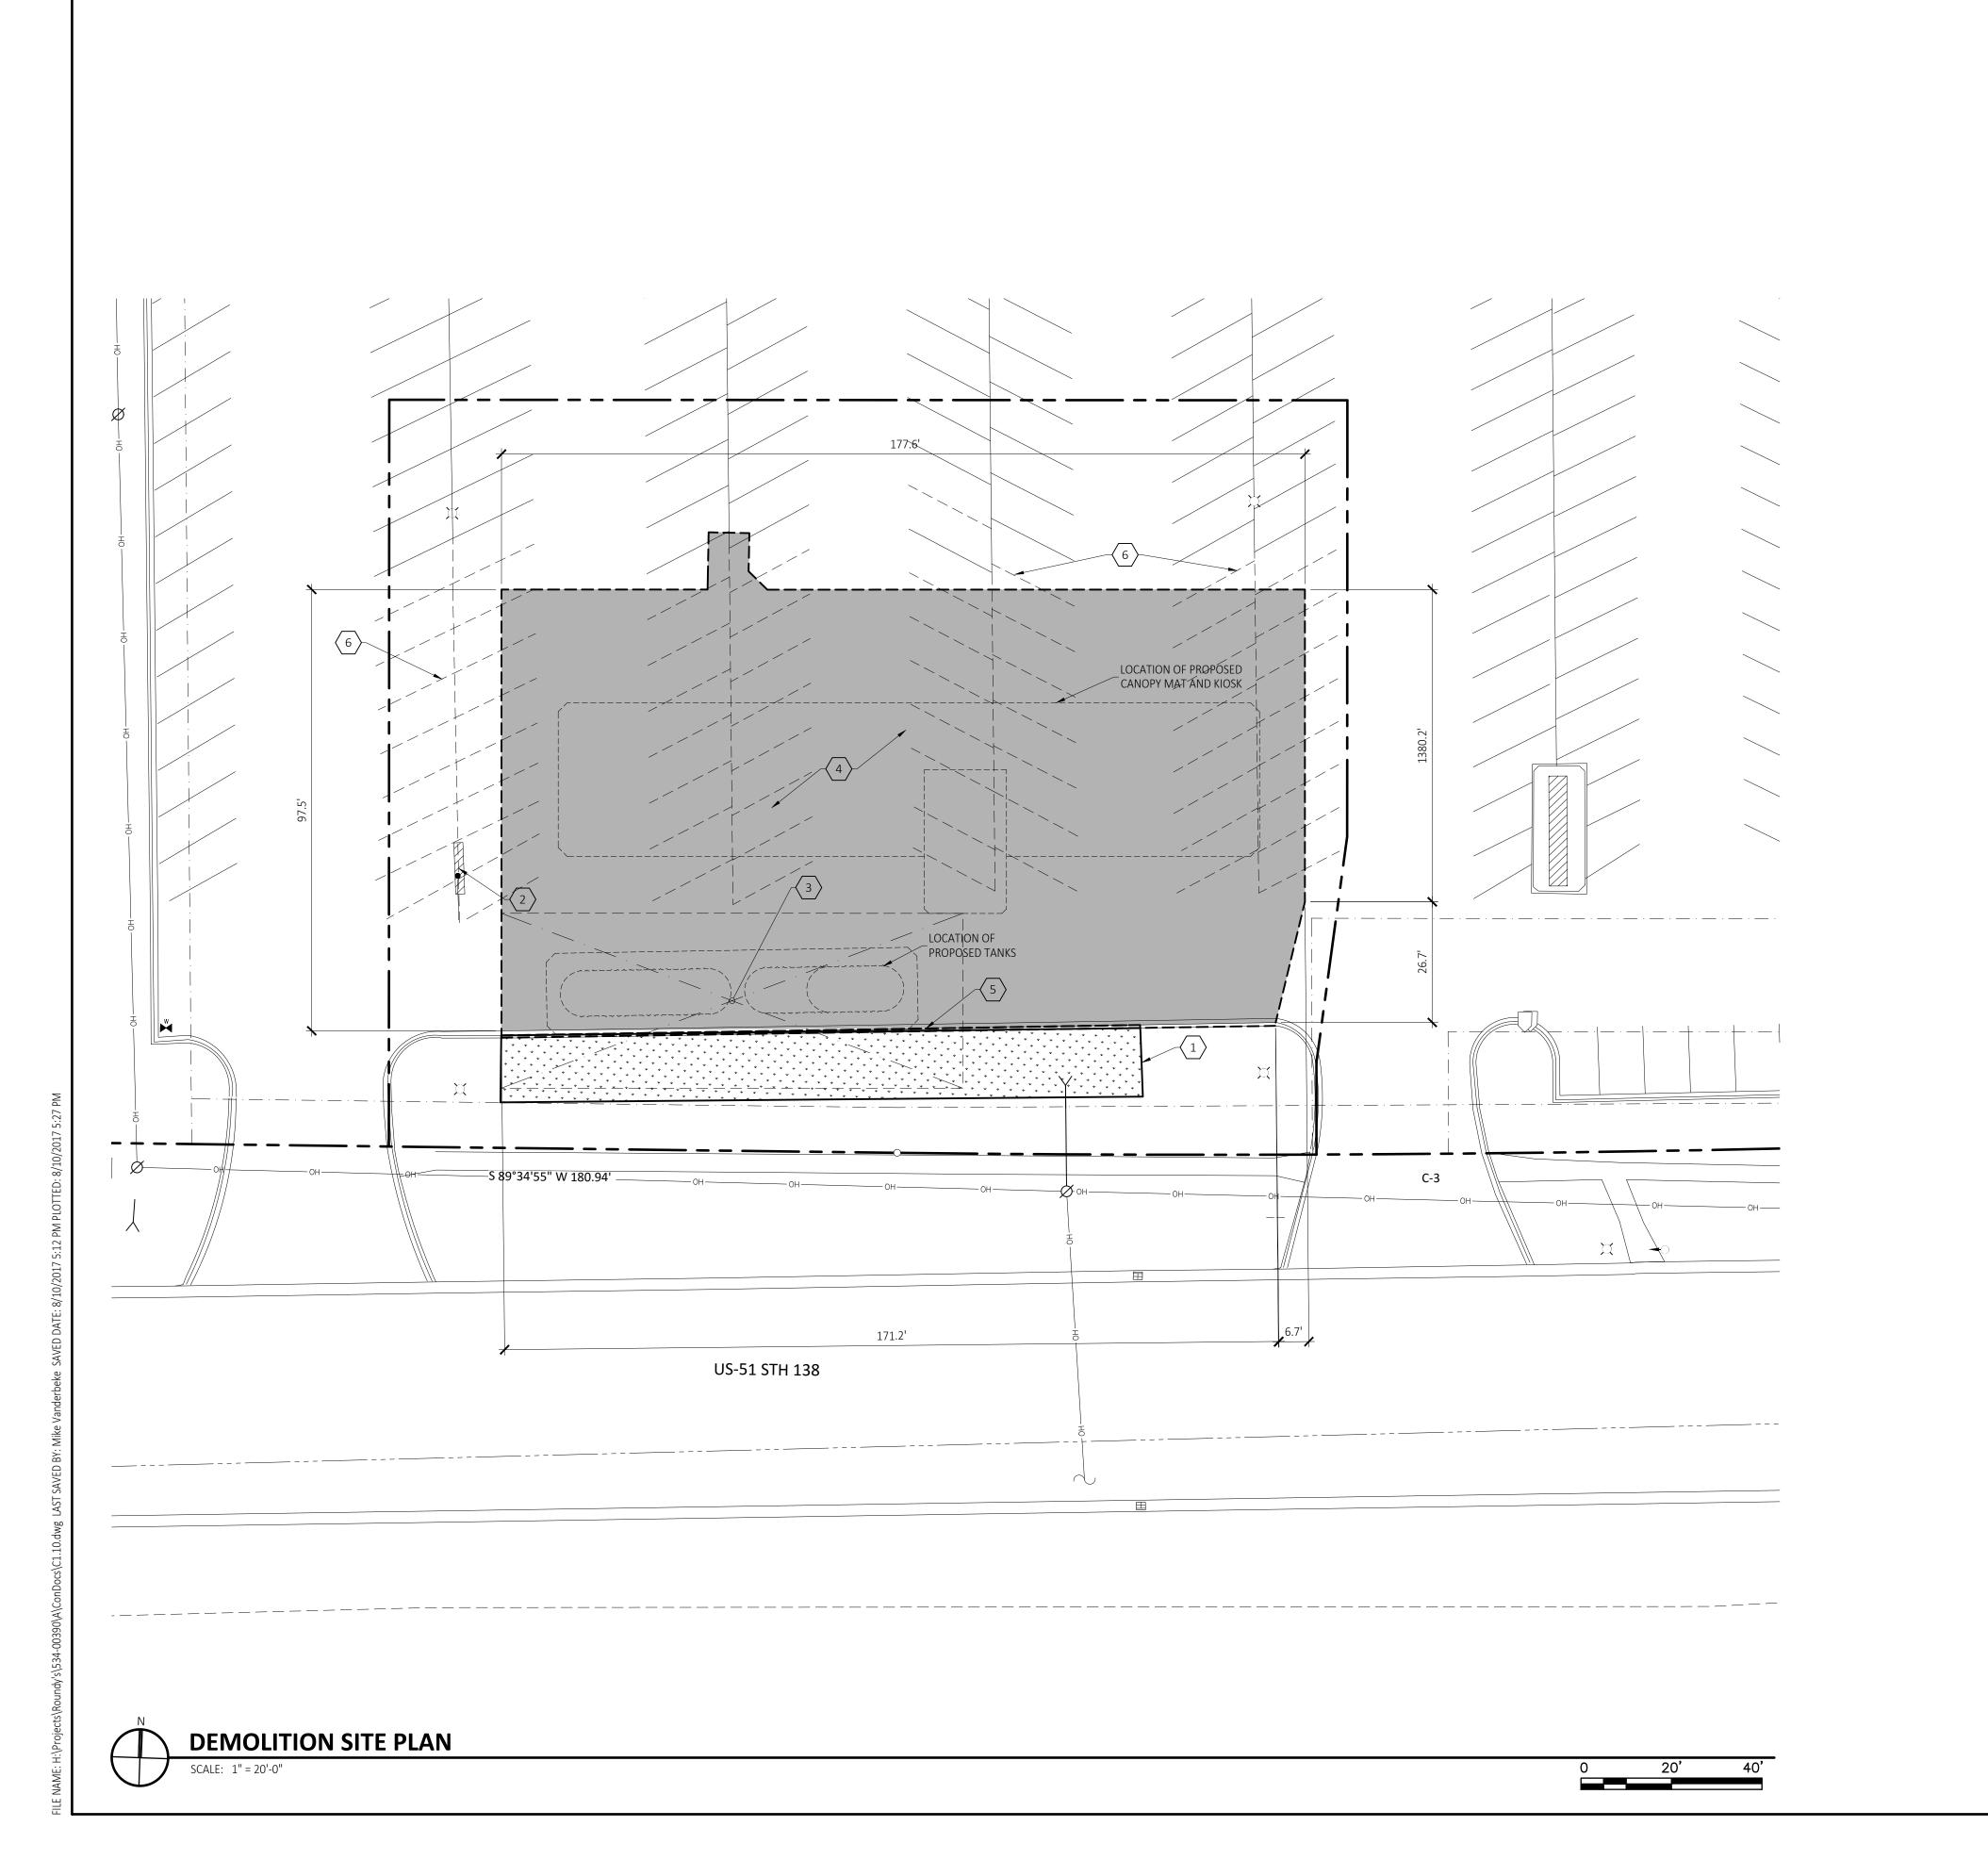

DEMOLITION SITE PLAN KEYNOTES:

- 1. REMOVE SOIL AND GRAVEL AND STORE FOR REUSE AS PRACTICAL. PREPARE SITE FOR NEW CONSTRUCTION AS INDICATED IN THE GEOTECHNICAL REPORT.
- 2. PROTECT PYLON SIGN AND FOUNDATIONS TO REMAIN.
- 3. APPROXIMATE TANK EXCAVATION LIMITS SHOWN FOR REFERENCE ONLY. ACTUAL TANK EXCAVATION REQUIREMENTS AND SIZING SHALL BE DETERMINED BY THE CONTRACTOR BASED ON SITE CONDITIONS AND GEOTECHNICAL ENGINEER'S REPORT. CONTRACTOR SHALL REVIEW EXISTING CONDITIONS AND PROVIDE SHORING AS REQUIRED.
- 4. SAWCUT, REMOVE AND DISPOSE OF PAVEMENT AS REQUIRED FOR NEW CONSTRUCTION.
- 5. SAWCUT, REMOVE AND DISPOSE OF CONCRETE CURB AS REQUIRED FOR NEW CONSTRUCTION.
- 6. SCARIFY EXISTING PARKING SPACES FOR NEW CONSTRUCTION.

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> Corporate Office: 4925 Forest Avenue Downers Grove, IL 60515

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REVISIONS				
DATE	DESCRIPTION			
08.10.2017	SITE PLAN/CONDITIONAL USE			

CONSULTANT

E-45202-6 PORTAGE

CUSTOMER

PROJECT DESCRIPTION

534-00390 RETAIL FUEL CENTER

PROJECT LOCATION

1750 HWY. 51 WEST STOUGHTON, WI 53589


(DANE COUNTY)

SHEET TITLE

DEMOLITION SITE PLAN

SHEET MAN	IAGEMENT
PROJECT NO.:	534-0039
DATE:	
CAD FILE:	C1.10.dw
PROJECT MANAGER:	T. KRAT
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SHEET NUMBER



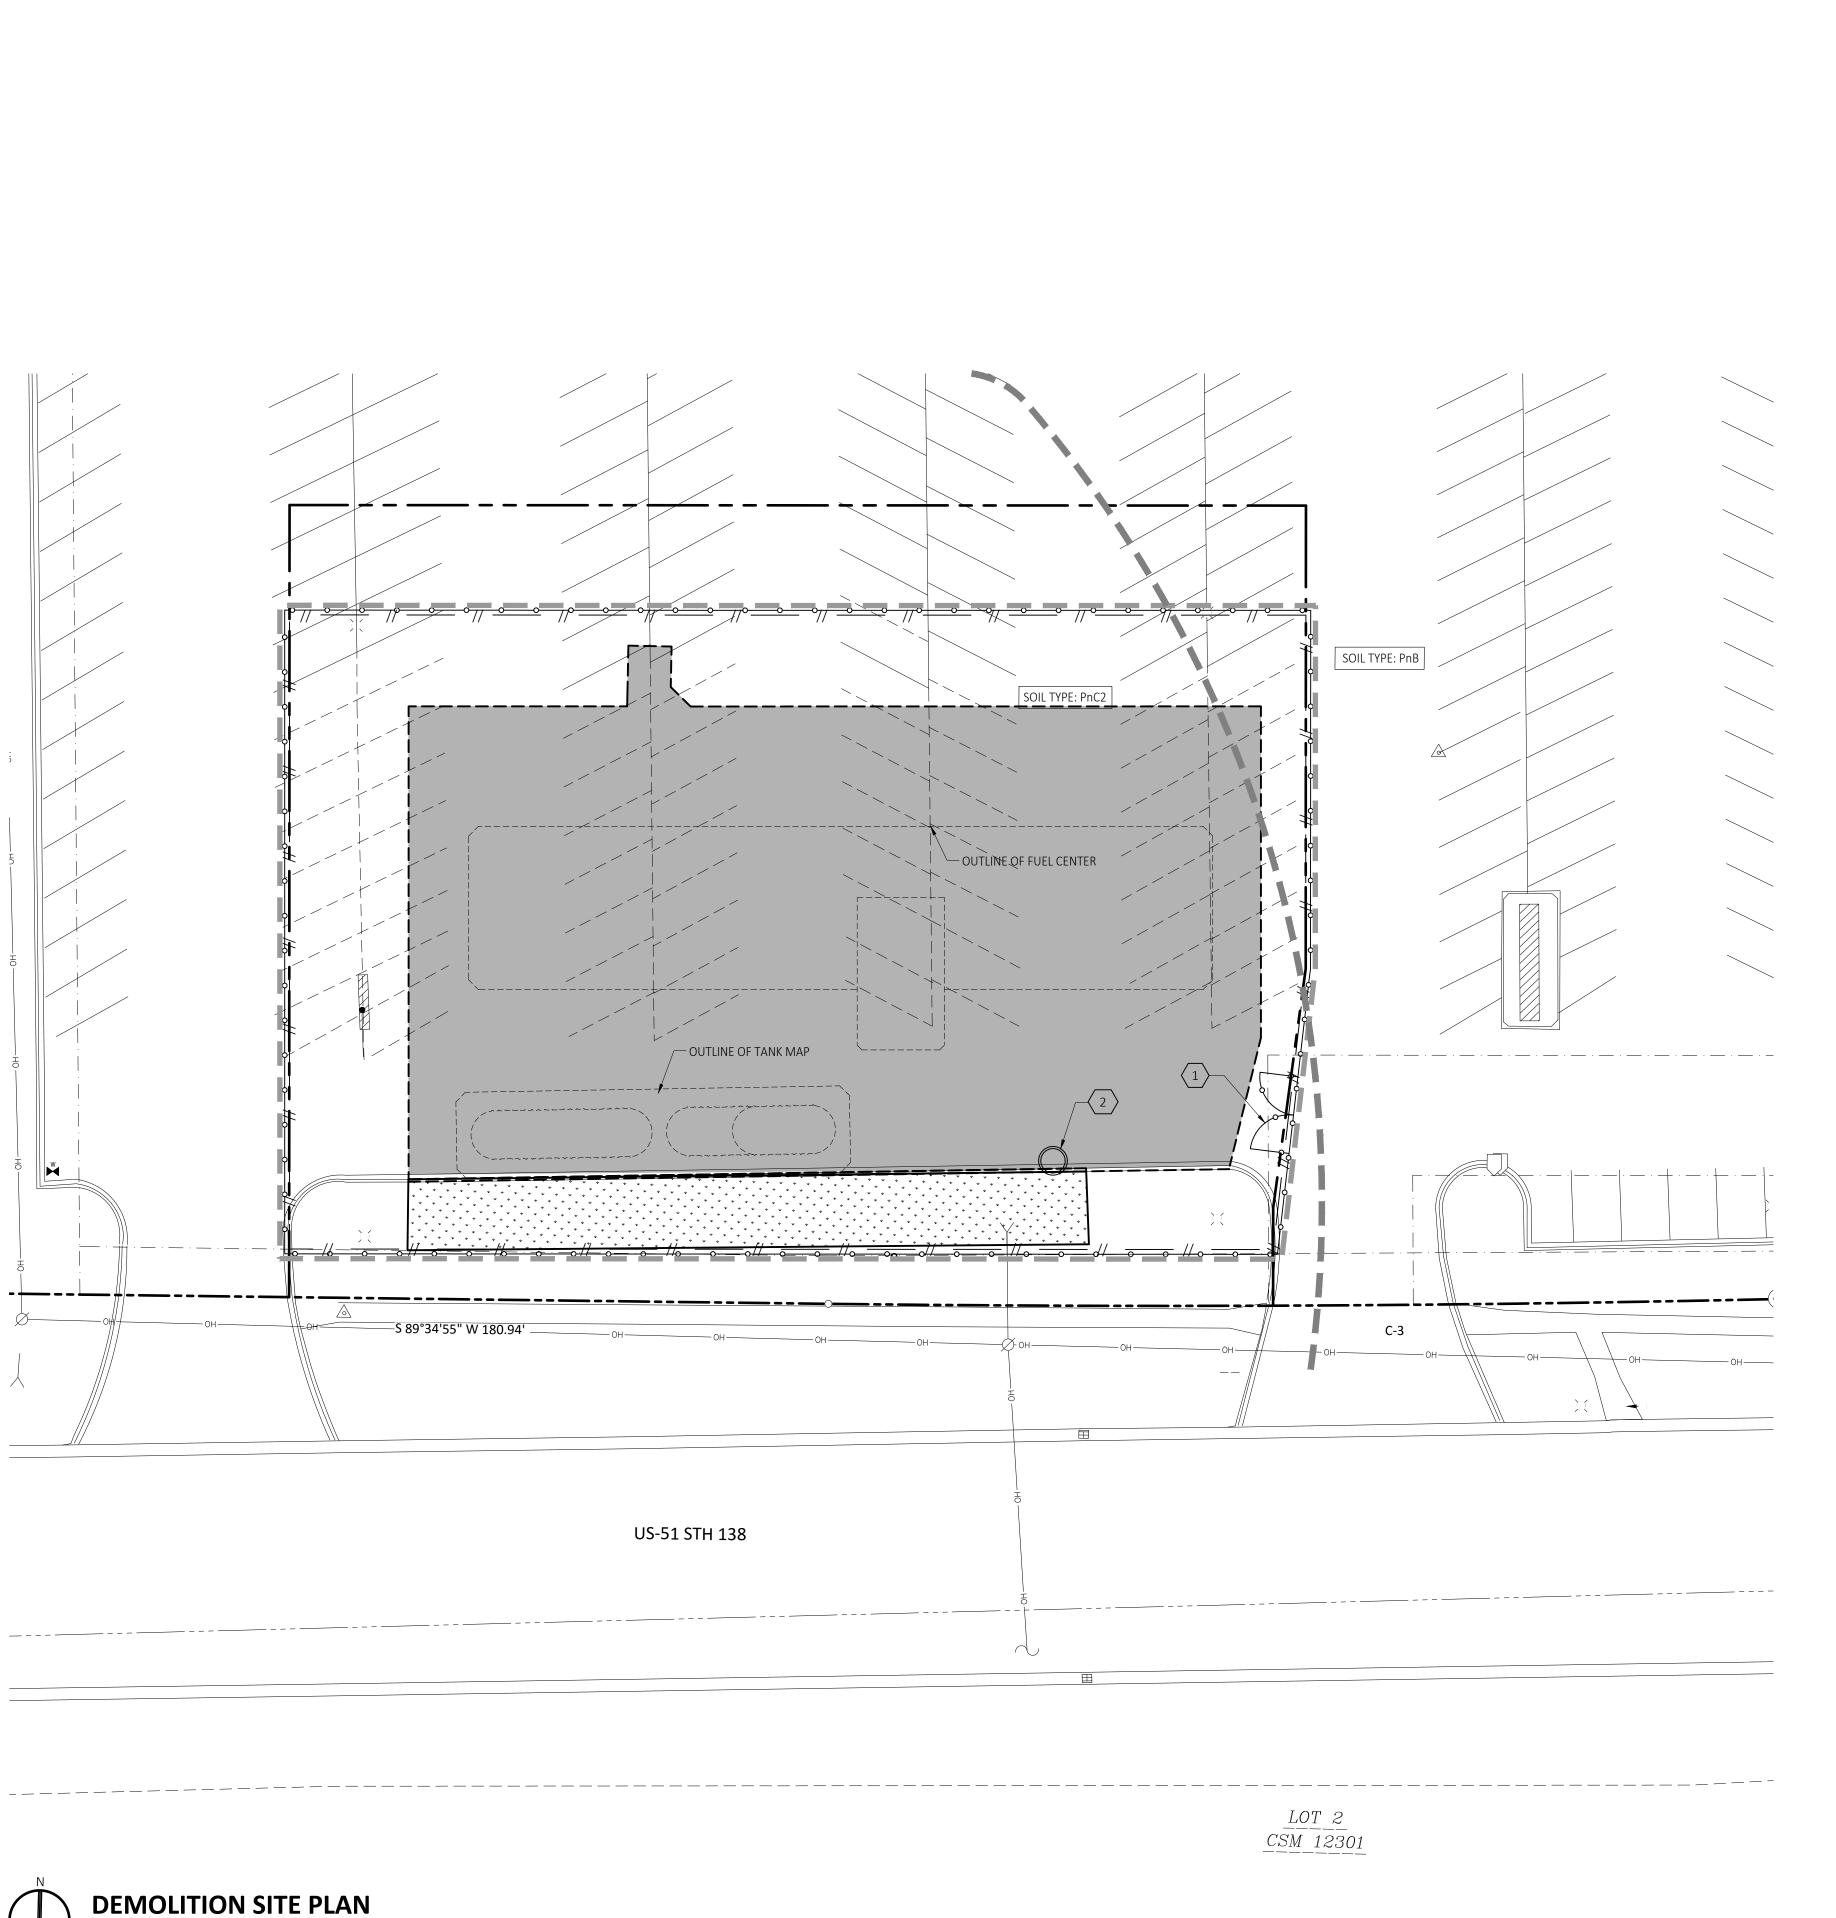

- 1. INSTALL CONSTRUCTION FENCE. CONTRACTOR TO FIELD VERIFY AND COORDINATE LOCATION(S) OF CONSTRUCTION ACCESS GATE(S) WITH OWNER'S REPRESENTATIVE. SEE DETAIL 7/C5.00. INCLUDE SILT FENCE INSIDE OF CONSTRUCTION FENCE.
- 2. PROVIDE AND INSTALL CONCRETE WASHOUT AREA. SEE DETAIL 6/C5.00.

CONSTRUCTION SITE DEWATERING NOTES

TAKE CARE WHEN DEWATERING CONSTRUCTION SITES. DO NOT PUMP SEDIMENT-LADEN WATER DIRECTLY TO LAKES, STREAMS, COUNTY DRAINS, STORM DRAINS, WETLANDS OR OTHER ENVIRONMENTALLY SENSITIVE AREAS. THE PROPER WAY TO DEWATER A CONSTRUCTION SITE IS AS

- PLACE A GEOTEXTILE FILTER BAG OR GEOTUBE ON THE END OF THE DISCHARGE HOSE.
- DISCHARGE DIRECTLY TO A SEDIMENT BASIN.

 DISCHARGE TO A WELL MEGETATED AREA (NOT WELL ANDS).
- DISCHARGE TO A WELL VEGETATED AREA (NOT WETLANDS).
 DISCHARGE INTO A CONSTRUCTED CONTAINMENT AREA.

DISSIPATE ENERGY TO PREVENT SCOURING, AND INSPECT DEWATERING OPERATIONS SEVERAL TIMES

SESC CONSTRUCTION SEQUENCE

- 1. IMPLEMENTATION OF TEMPORARY EROSION CONTROL MEASURES; SELECTIVE GRADING DIVERSIONS AS REQUIRED IN FIELD, AND PROTECTION OF STORM SEWER FACILITIES.
- 2. PAVEMENT DEMOLITION; STRIP AND STOCK PILE SOIL.
- 3. PERIODIC MAINTENANCE OF AFFECTED EROSION CONTROL MEASURES.
- 4. PERMANENT MEASURES; FINAL GRADING, SEEDING AND MULCHING.

CONSTRUCTION SEQUENCE :

CONSTRUCTION ENTRANCE

CONSTRUCTION FENCE

LIMITS OF DISTURBANCE

SILT FENCE

TREE FENCE

INLET FILTER

- 1. INSTALL TRAFFIC AND PEDESTRIAN SAFETY BARRICADES.
- 2. INSTALL TEMPORARY EROSION CONTROL MEASURES. PROTECT ALL AREAS THAT COULD ALLOW SEDIMENT TO MIGRATE OFF-SITE VIA SURFACE RUNOFF, VIA ENCLOSED DRAINAGE SYSTEMS OR VIA TRACKING CAUSED BY CONSTRUCTION EQUIPMENT, ETC. EROSION AND SEDIMENT CONTROL MEASURES SHALL BE INSTALLED PRIOR TO ANY EARTH MOVING ACTIVITIES.
- 3. COMPLETE REQUIRED REMOVALS AND LEGALLY DISPOSE OF DEBRIS AND WASTE OFF-SITE.
- 4. PERFORM MASS GRADING AND CONSTRUCT SITE IMPROVEMENTS.
- 5. DAILY OR AS REQUIRED, CONSTRUCT TEMPORARY BERMS, DITCHES, SILT FENCING, SEDIMENT TRAPS, ETC. SEED AND MULCH AS REQUIRED.
- 6. INSPECT AND MAINTAIN ALL EROSION CONTROL MEASURES PER JURISDICTIONAL AUTHORITY REQUIREMENTS
- 7. REMOVE TEMPORARY EROSION CONTROL MEASURES WHEN SITE IS STABILIZED.

SOIL EROSION AND SEDIMENTATION CONTROL NOTES AND MAINTENANCE NOTES

AND SPECIFICATIONS OF THE JURISDICTIONAL AUTHORITY.

- 1. LANDOWNER OR LANDOWNER'S REPRESENTATIVE SHALL SUBMIT A SOIL EROSION CONTROL PLAN AND OBTAIN A SOIL EROSION AND SEDIMENTATION CONTROL PERMIT PRIOR TO ANY EARTH CHANGES.
- 2. THIS PROJECT SHALL BE CONSTRUCTED IN COMPLIANCE WITH THE "WISCONSIN CONSTRUCTION SIDE BEST MANAGEMENT PRACTICE HANDBOOK" BY THE STATE OF WISCONSIN DNR.
- ALL SOIL EROSION AND SEDIMENTATION CONTROL (SESC) WORK SHALL CONFORM TO THE STANDARDS
- 4. EROSION AND ANY SEDIMENTATION FROM WORK ON THIS SITE SHALL BE CONTAINED ON THE SITE AND NOT ALLOWED TO COLLECT ON ANY OFF SITE AREAS OR IN WATERWAYS. WATERWAYS INCLUDE BOTH NATURAL AND MAN MADE OPEN DITCHES, STREAMS, STORM DRAINS, LAKES AND PONDS.
- 5. STAGING THE WORK WILL BE DONE BY THE LANDOWNER OR LANDOWNER'S REPRESENTATIVE AS DIRECTED IN THESE PLANS AND AS REQUIRED TO ENSURE PROGRESSIVE STABILIZATION OF DISTURBED EARTH CHANGE.
- 6. THE LANDOWNER OR LANDOWNER'S REPRESENTATIVE SHALL BE RESPONSIBLE FOR INSTALLATION AND MAINTENANCE OF SESC DEVICES.
- 7. THE LANDOWNER OR LANDOWNER'S REPRESENTATIVE SHALL IMPLEMENT AND MAINTAIN THE SESC MEASURES AS SHOWN ON THE PLANS BEFORE, AND AT ALL TIMES DURING, THE CONSTRUCTION ON THIS PROJECT. ANY MODIFICATIONS OR ADDITIONS TO SESC MEASURES DUE TO CONSTRUCTION OR CHANGED CONDITIONS SHALL BE COMPLIED WITH AS REQUIRED OR DIRECTED BY THE JURISDICTIONAL AUTHORITY.
- 8. IF ANY OF THE SESC MEASURES ON THE SITE ARE DEEMED INADEQUATE OR INEFFECTIVE, THE JURISDICTIONAL AUTHORITY HAS THE RIGHT TO REQUIRE ADDITIONAL SESC MEASURES AT THE EXPENSE OF THE LANDOWNER.
- 9. LANDOWNER OR LANDOWNER'S REPRESENTATIVE SHALL INSPECT THE SESC DEVICES ONCE A WEEK, WITHIN 24 HOURS OF RAINFALL, AND DAILY DURING A PROLONGED RAIN EVENT. A LOG OF INSPECTION REPORTS SHALL BE MAINTAINED AND ACCESSIBLE IN ACCORDANCE WITH NATIONAL POLLUTION DISCHARGE ELIMINATION SYSTEM (NPDES) REQUIREMENTS. REQUIRED MAINTENANCE SHALL BE PROVIDED PROMPTLY.
- 10. INSTALL SILT FENCE AS INDICATED ON THE PLAN, PER DETAIL, AND AT ADDITIONAL AREAS AS NECESSARY.
 A. SILT FENCE SHALL BE INSPECTED WEEKLY UNDER NORMAL CONDITIONS, WITHIN 24 HOURS OF RAINFALL, AND DAILY DURING A PROLONGED RAIN EVENT. REQUIRED MAINTENANCE SHALL BE
 - PROVIDED PROMPTLY.

 B. BUILD-UP OF SEDIMENT SHALL BE REMOVED WHEN SEDIMENT ACCUMULATES TO 1/3 TO 1/2 OF THE HEIGHT OF THE SILT FENCE.
- C. IF SILT FENCE DECOMPOSES OR BECOMES INEFFECTIVE PRIOR TO THE END OF EXPECTED USABLE LIFE AND THE BARRIER IS STILL REQUIRED, THE SILT FENCE SHALL BE REPLACED PROMPTLY.
- 11. INSTALL INLET FILTER ON ALL PAVEMENT CATCH BASINS PER DETAIL.

 A. INLET FILTERS SHALL BE INSPECTED WEEKLY UNDER NORMAL CONDITIONS, WITHIN 24 HOURS OF A RAINFALL AND DAILY DURING A PROLONGED RAIN EVENT. REQUIRED MAINTENANCE SHALL BE
 - PROVIDED PROMPTLY.

 B. BUILD-UP OF SEDIMENT AND DEBRIS SHALL BE REMOVED PROMPTLY.

 C. IF FILTER FABRIC DECOMPOSES OR BECOMES INEFFECTIVE PRIOR TO THE END OF EXPECTED USABLE LIFE AND THE BARRIER IS STILL REQUIRED, THE FILTER FABRIC SHALL BE REPLACED PROMPTLY.
- 12. INSTALL DRAIN GUARD ON ALL CATCH BASINS PER DETAIL, SEED OR SOD THE AREA BETWEEN THE SILT FENCE AND THE INLET.
- A. DRAIN GUARDS SHALL BE INSPECTED WEEKLY UNDER NORMAL CONDITIONS, WITHIN 24 HOURS OF RAINFALL AND DURING A PROLONGED RAIN EVENT. REQUIRED MAINTENANCE SHALL BE PROVIDED
- B. BUILD-UP OF SEDIMENT SHALL BE REMOVED WHEN SEDIMENT ACCUMULATES TO 1/3 TO 1/2 OF THE HEIGHT OF THE SILT FENCE.
 C. IF FILTER FABRIC DECOMPOSES OR BECOME INEFFECTIVE PRIOR TO THE END OF EXPECTED USABLE
- LIFE AND THE BARRIER IS STILL REQUIRED, THE FILTER FENCE SHALL BE REPLACED PROMPTLY.

 13. ALL STOCKPILED SOILS SHALL BE MAINTAINED IN SUCH A WAY AS TO PREVENT EROSION FROM LEAVING
- THE SITE. SILT FENCE MUST BE INSTALLED AROUND THE PERIMETER OF THE STOCKPILE. IF THE STOCKPILE WILL BE ON SITE FOR MORE THAN 30 DAYS, THEN THE STOCKPILE MUST BE SEEDED.

 A. IMMEDIATELY AFTER SEEDING, MULCH ALL SEEDED AREAS WITH UNWEATHERED SMALL GRAIN STRAW, SPREAD UNIFORMLY AT THE RATE OF 1 TO 2 TONS PER ACRE OR 100 POUNDS (2-3 BALES)
- PER 1000 SQUARE FEET.

 B. THE MULCH SHOULD BE ANCHORED WITH DISC TYPE MULCH ANCHORING TOOL OR OTHER MEANS AS APPROVED BY THE JURISDICTIONAL AUTHORITY. MULCH MATTING MAY BE USED IN LIEU OF LOOSE MULCH.
- 14. IF ANY DEWATERING IS NEEDED, IT SHALL BE DISCHARGED THROUGH A FILTER BAG OVER A WELL-VEGETATED AREA. THE PUMP MUST DISCHARGE AT A NON-EROSIVE VELOCITY. IF NECESSARY, AN APPROVED ENERGY DISSIPATER MAY BE USED.
- 15. CONSTRUCTION ACCESS TO BE FROM THE EXISTING PARKING LOT.
- 16. ALL MUD, DIRT, AND DEBRIS TRACKED ONTO THE PARKING LOT OR ANY ROADWAY SHALL BE REMOVED
- 17. STREETS AND/OR PARKING AREAS WILL BE SCRAPED AND SWEPT ON A DAILY BASIS BY THE LANDOWNER OR LANDOWNER'S REPRESENTATIVE.
- 18. ALL DISTURBED AREAS SHALL BE MAINTAINED FOR DUST CONTROL. SPRINKLING TANK TRUCKS SHALL BE AVAILABLE AT ALL TIMES AND USED ON HAUL ROADS, ON-SITE DISTURBED AREAS, AND OTHER AREAS WHERE DUST BECOMES A PROBLEM AS A RESULT OF CONSTRUCTION ACTIVITY.
- 19. PERMANENT SESC MEASURES FOR ANY DISTURBED LAND AREA SHALL BE COMPETED WITHIN 5 CALENDAR DAYS AFTER FINAL GRADING OR THE FINAL EARTH CHANGE HAS BEEN COMPLETED. WHEN IT IS NOT POSSIBLE TO PERMANENTLY STABILIZE A DISTURBED AREA AFTER EARTH CHANGE ACTIVITY CEASES, TEMPORARY SESC MEASURES SHALL BE IMPLEMENTED IMMEDIATELY. ALL TEMPORARY SESC MEASURES SHALL BE MAINTAINED UNTIL PERMANENT SESC MEASURES ARE IMPLEMENTED. ALL PERMANENT SESC MEASURES WILL BE IMPLEMENTED AND ESTABLISHED BEFORE A CERTIFICATE OF COMPLIANCE IS ISSUED.
- 20. FINAL GRADE, ESTABLISH VEGETATION, AND/OR LANDSCAPE ALL DISTURBED AREAS NOT BUILT OR PAVED
- 21. REMOVE ALL TEMPORARY SESC DEVICES AFTER PERMANENT STABILIZATION IS ESTABLISHED.
- 22. SOIL TYPE(S): PnC2: PLANO SILT LOAM, TILL SUBSTRATUM, 6 TO 12 PERCENT SLOPES, ERODED PnB: PLANO SILT LOAM, TILL SUBSTRATUM, 2 TO 6 PERCENT SLOPES
- 23. ESTIMATED RUNOFF COEFFICIENT BEFORE CONSTRUCTION: .90 ESTIMATED RUNOFF COEFFICIENT AFTER CONSTRUCTION: .90 I
- 24. DEPTH TO GROUNDWATER: REFER TO GEOTECHNICAL REPORT
- 25. TOTAL ACRES DISTURBED = .67 ACRES
- 26. PERSON RESPONSIBLE FOR MAINTENANCE OF ALL TEMPORARY AND PERMANENT SOIL EROSION CONTROL MEASURES: ERIC KRAWCZYK (414) 403-3656

TIMOTHY B
KRATZ
E-45202-6
PORTAGE
IN

08.10.2017

CUSTOMER

Regional Office:

37704 Hills Tech Drive

Farmington Hills, MI 48331 734.367.4445 Telephone

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4925 Forest Avenue

Downers Grove, IL 60515

SAFETY - INTEGRITY - SUSTAINABIL

REVISIONS

08.10.2017 SITE PLAN/CONDITIONAL USE

CONSULTANT

. DATE DESCRIPTION

PROJECT DESCRIPTION

534-00390 RETAIL FUEL CENTER

PROJECT LOCATION

1750 HWY. 51 WEST **STOUGHTON, WI** 53589

(DANE COUNTY)

SHEET TITLE

SOIL EROSION AND SEDIMENT CONTROL PLAN

SHEET MANAGEN	MENT
PROJECT NO.:	534-0039
DATE:	
CAD FILE:	C1.11.dw
PROJECT MANAGER:	T. KRAT
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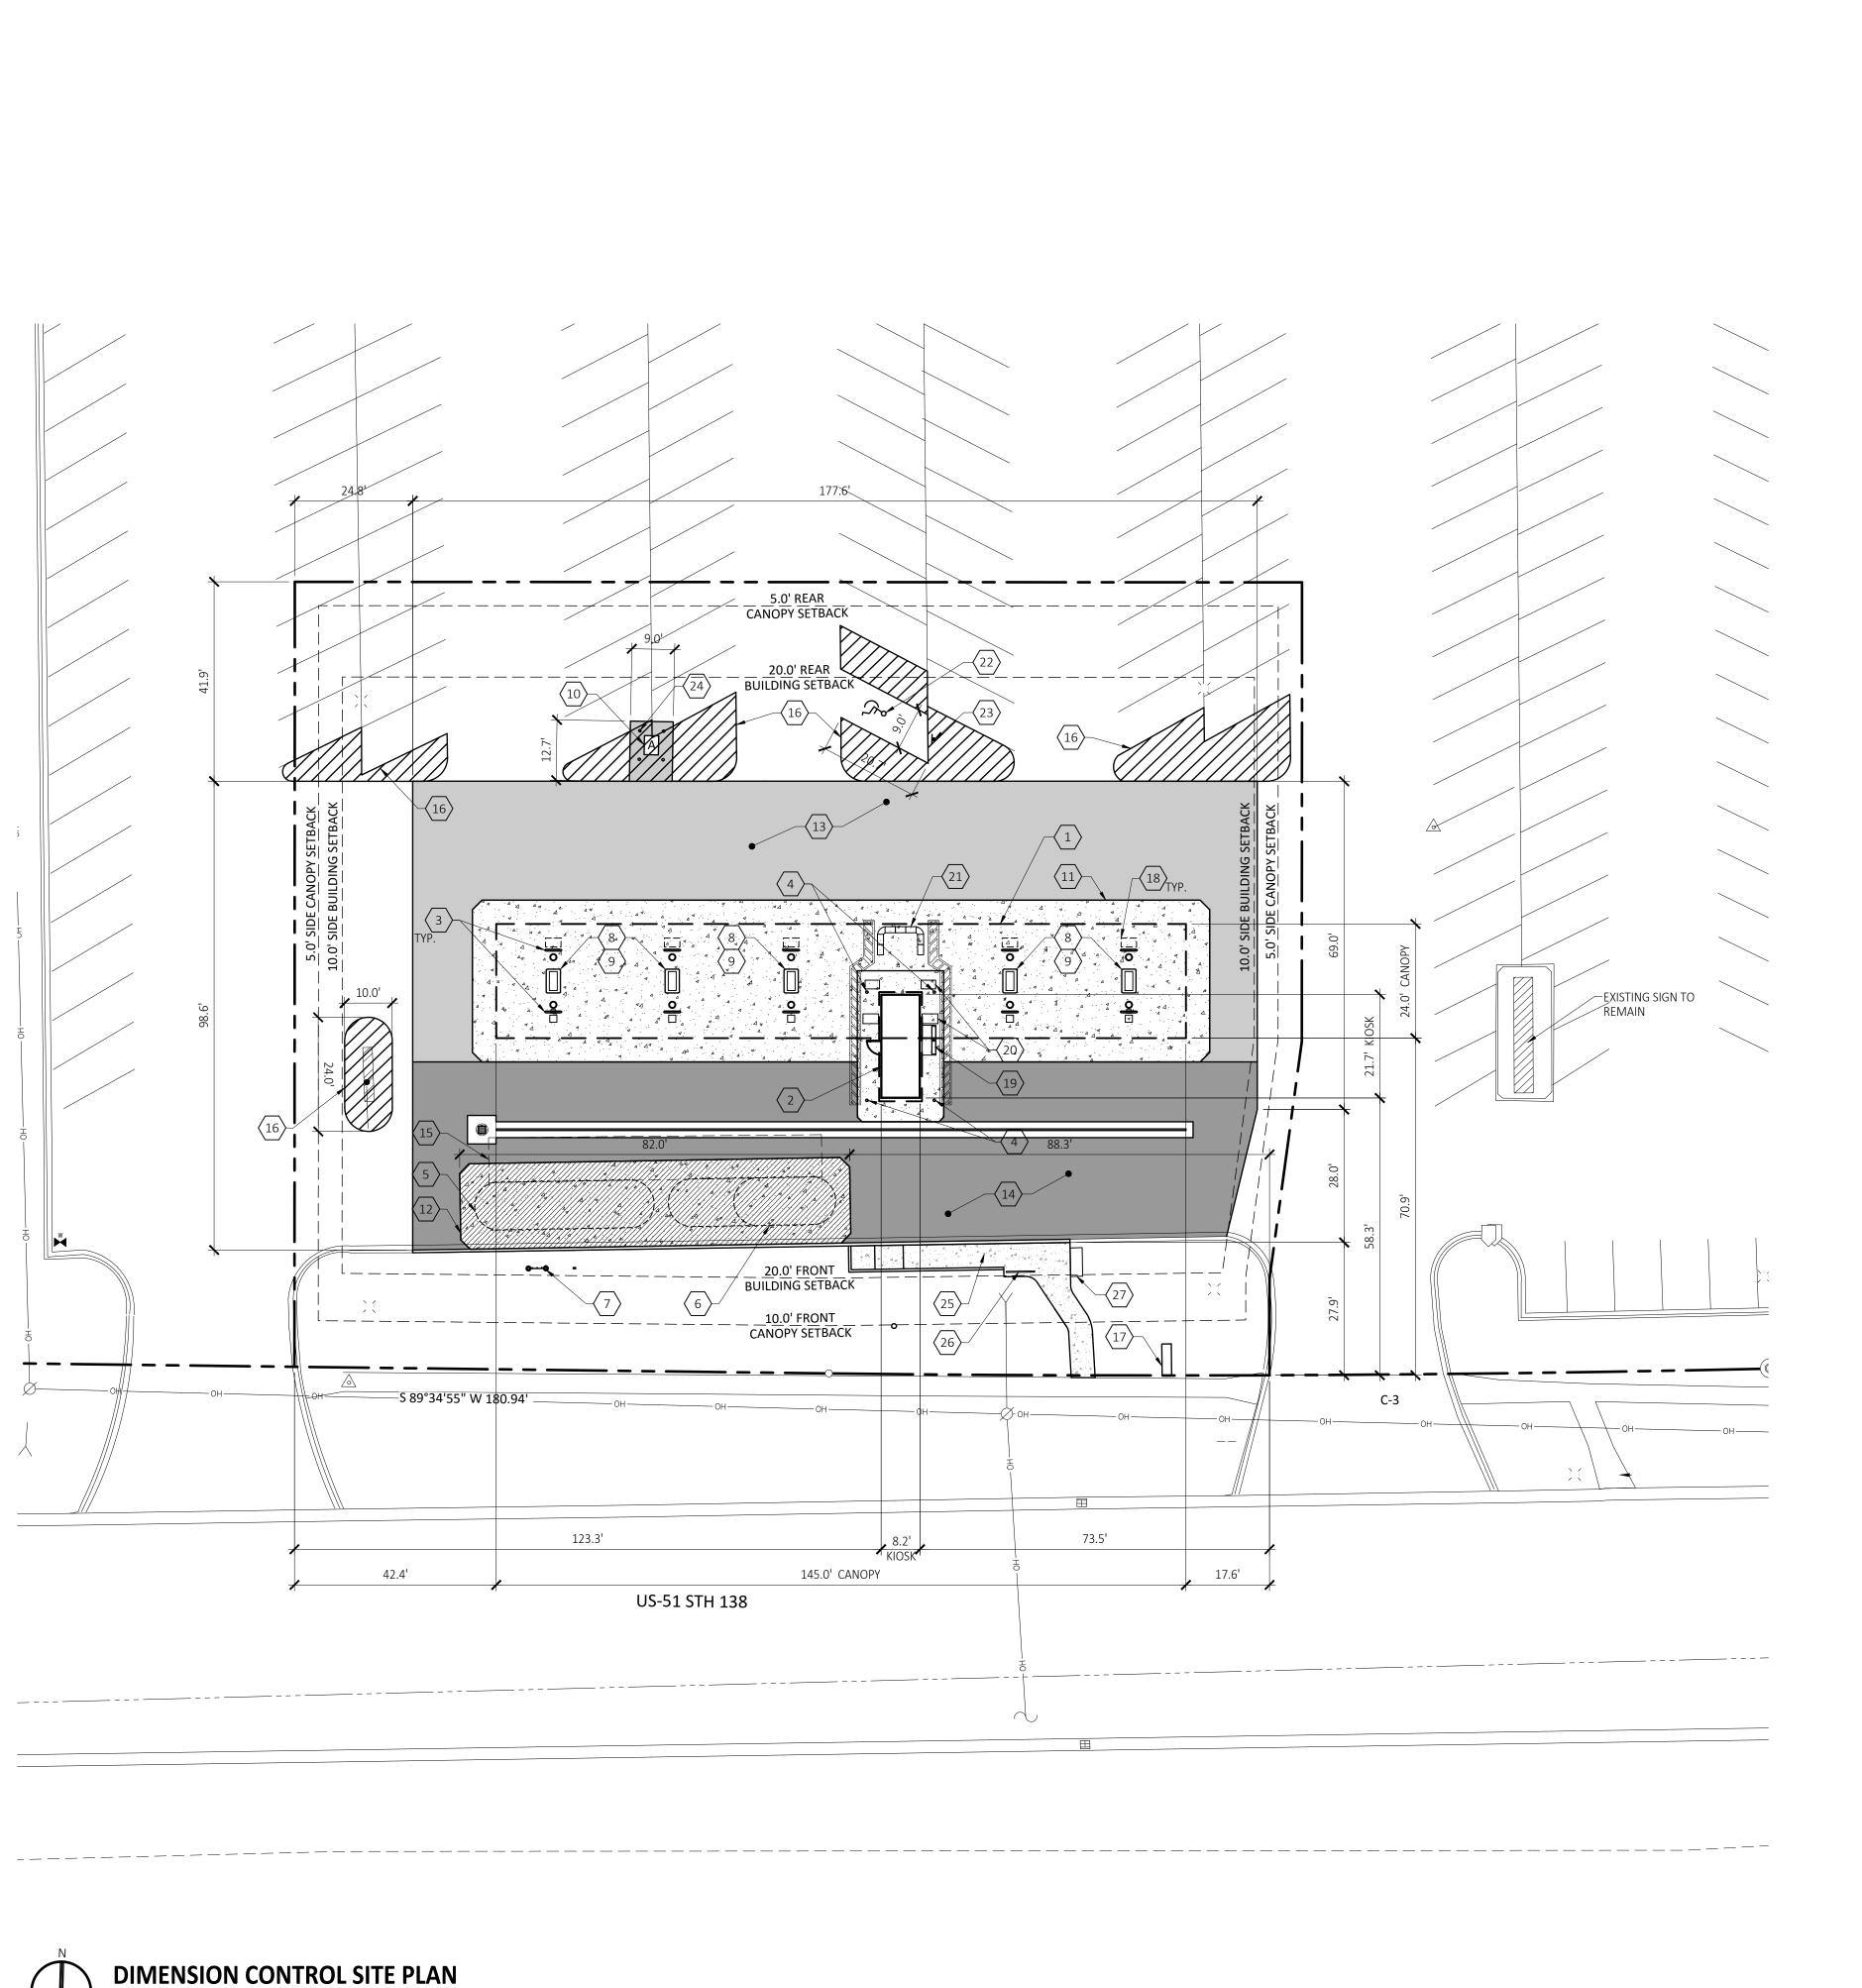
C1.11

SHEET NUMBER

 CONSTRUCTION OPERATION TIME SCHEDULE

 CONSTRUCTION SEQUENCE
 1
 2
 3
 4
 5
 6
 7
 8
 9
 10
 11
 12
 13
 14
 15
 16

 1
 INSTALL SESC MEASURES
 INSTALL SESC MEASURES



X PROPOSED SITE IMPROVEMENTS:

- 1. DISPENSER CANOPY, CANOPY COLUMNS AND FOOTINGS.
- 2. TRANSACTION KIOSK.
- 3. U-SHAPED BOLLARD AT CANOPY COLUMNS.
- 4. KIOSK BOLLARD.
- 5. 20,000 GALLON DOUBLE-WALL UNDERGROUND STORAGE TANK (UNLEADED).
- 6. 18,000 GALLON DOUBLE-WALL SPLIT UNDERGROUND STORAGE TANK 8,000 GALLONS PREMIUM/10,000 GALLONS DIESEL.
- 7. TANK VENT RISER AND TANK OVERFLOW ALARM.
- 8. 3.00' X 5.00' DISPENSER ISLAND.
- 9. AUTOMOBILE MULTI-PRODUCT DISPENSER WITH CARD READER.
- 10. AIR TOWER, ALL ASSOCIATED EQUIPMENT AND UTILITIES REQUIRED TO PROVIDE PROPER SERVICE.
- 11. CONCRETE DISPENSER MAT.
- 12. CONCRETE TANK MAT.
- 13. LIGHT DUTY BITUMINOUS PAVEMENT.
- 14. HEAVY DUTY BITUMINOUS PAVEMENT.
- 15. 10.00'x70.00' LOADING ZONE.
- 16. PAINTED ISLAND.
- 17. MONUMENT SIGN. LOCATION SHOWN FOR REFERENCE. MONUMENT SIGN TO RECEIVE SEPARATE
- 18. NESTING CAGE (22.5"X39"X56") 2 PULL OUT SHELVES FOR PERMANENT OUTDOOR SALES.
- 19. ICE MERCHANDISER.
- 20. SODA MACHINE.
- 21. OUTDOOR SALES MERCHANDISER.
- 22. BARRIER-FREE VAN ACCESSIBLE PARKING SPACE.
- 23. BARRIER-FREE VAN ACCESSIBLE PARKING SIGN.
- 24. CONCRETE FILLED PIPE BOLLARD(4) SEE DETAIL 9/C5.00.
- 25. CONCRETE SIDEWALK.
- 26. BIKE RACK.
- 27. BENCH.

PAVING I FGFND



LITE DUTY ASPHALT PAVEMENT



CONCRETE PAVEMENT TANK MAT

HEAVY DUTY ASPHALT PAVEMENT



CONCRETE PAVEMENT DISPENSER MAT

Sevan

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Corporate Office:
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Downers Grove, IL 60515

info@sevansolutions.com www.sevansolutions.c

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REVISIONS

O. DATE DESCRIPTION
O 07.13.2017 CITY REVIEW
1 08.10.2017 SITE PLAN/CONDITIONAL USE

CONSULTANT

TIMOTHY B
KRATZ
E-45202-6
PORTAGE
IN

CUSTOMER

Pick 'n Save

PROJECT DESCRIPTION

534-00390 RETAIL FUEL CENTER

PROJECT LOCATION

1750 HWY. 51 WEST **STOUGHTON, WI** 53589

(DANE COUNTY)

SHEET TITLE

DIMENSION CONTROL SITE PLAN

SHEET MANAGEMENT

PROJECT NO.: 534-00390


DATE:
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PROJECT MANAGER: T. KRATZ

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SHEET NUMBER

0 20' 40'



BENCH MARK:

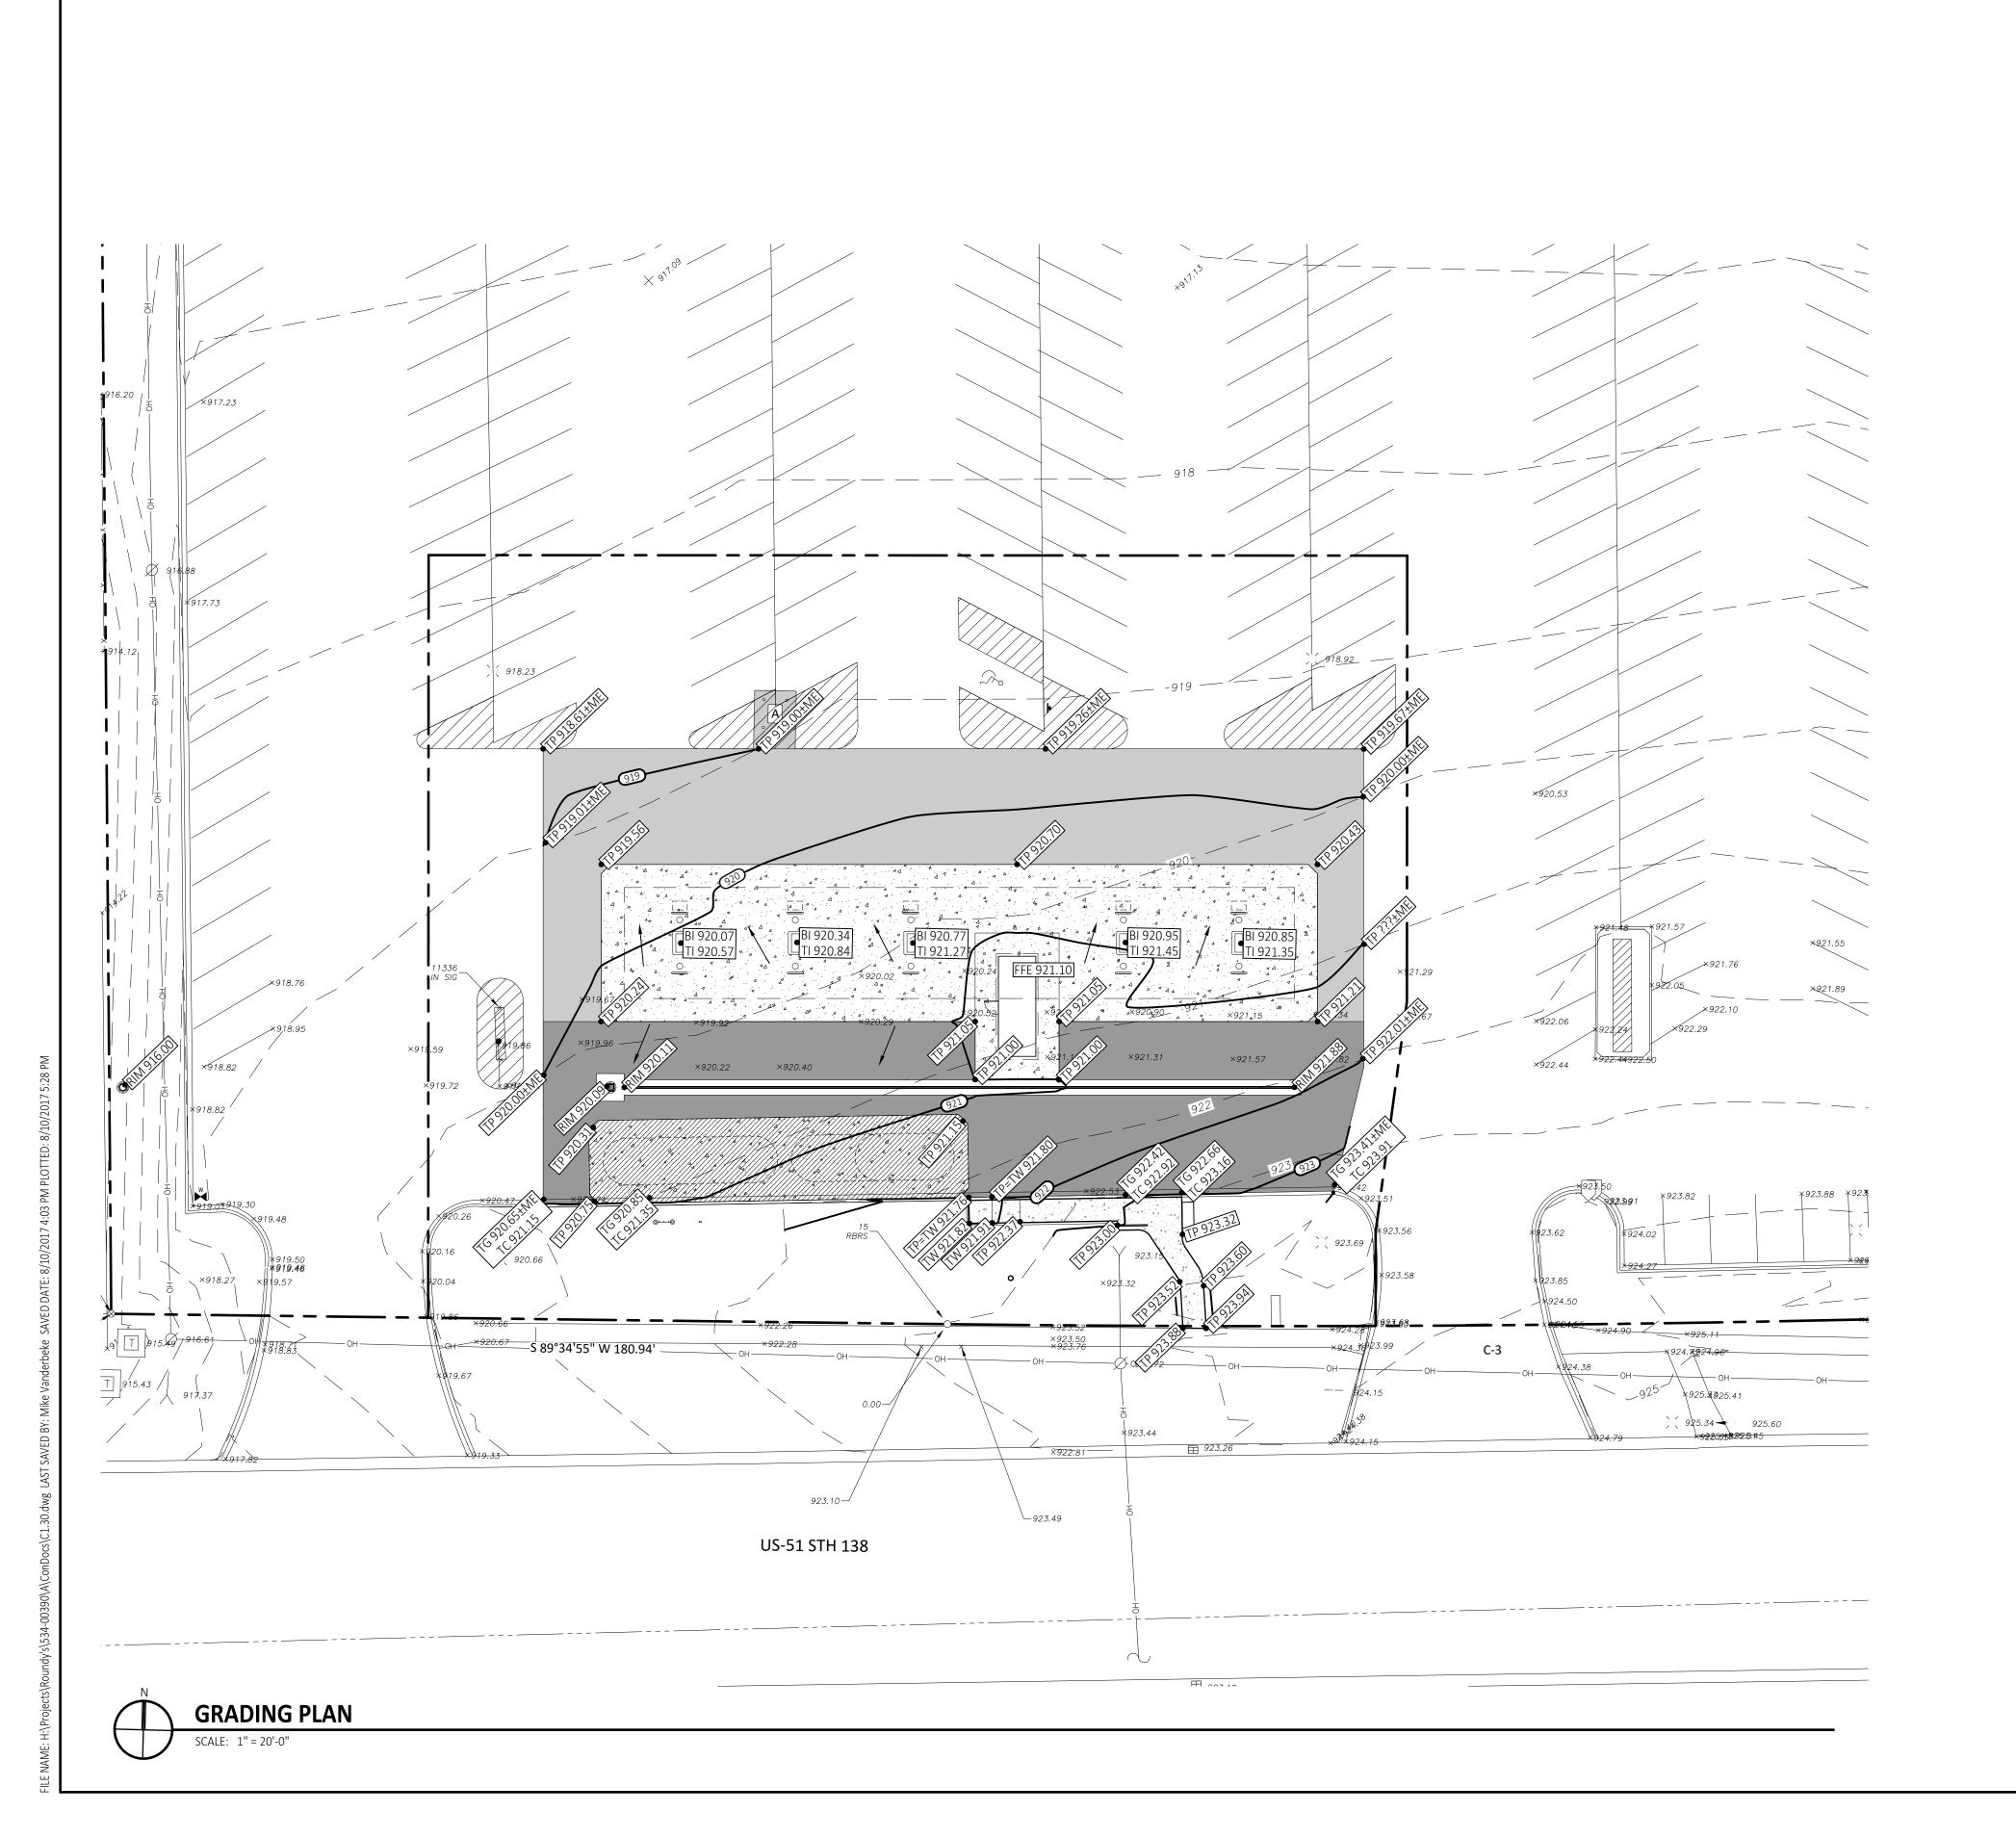AS PER SURVEY NOTES:

ELEVATIONS ARE BASED ON THE NORTH AMERICAN VERTICAL DATUM OF 1988 (NAVD88). BENCHMARK IS AN ALUMINUM MONUMENT MARKING THE SOUTH QUARTER CORNER OF SECTION 6, T5N, R11E, ELEVATION = 927.42'

GRADING NOTES:

- 1. REFER TO SHEET C1.11 FOR EROSION CONTROL NOTES AND DETAILS.
- 2. VERIFY REQUIRED SPOT ELEVATIONS/GRADING IN THE VICINITY OF THE BUILDING WITH THE ARCHITECTURAL PLANS.
- 3. ALL MATERIALS AND CONSTRUCTION METHODS SHALL BE IN CONFORMANCE WITH THE DRAWINGS AND PROJECT MANUAL, AND WITH LOCAL JURISDICTIONAL AUTHORITY STANDARDS AND SPECIFICATIONS.
- 4. ALL PROPOSED SPOT ELEVATIONS IN PAVED AREAS ARE TO TOP OF PAVEMENT UNLESS NOTED OTHERWISE.
- 5. THE PROJECT SITE SHALL BE GRADED TO PROVIDE POSITIVE DRAINAGE AT ALL TIMES, ENSURING NO AREAS OF STANDING WATER.
- 6. THE GENERAL CONTRACTOR SHALL, AT HIS OR HER EXPENSE, RESTORE ANY AND ALL STRUCTURES, PIPE, UTILITY, PAVEMENT, CURB, SIDEWALK, LANDSCAPED AREA, ETC. DISTURBED WITHIN THE SITE AND/OR ADJOINING PROPERTIES DURING DEMOLITION OR CONSTRUCTION. SUCH FACILITIES SHALL BE RESTORED TO THEIR ORIGINAL CONDITION OR BETTER, TO THE SATISFACTION OF THE AFFECTED OWNER(S).
- 7. UNDERDRAINS MAY BE ADDED, IF DETERMINED NECESSARY BY THE GENERAL CONTRACTOR AND AUTHORIZED BY THE OWNER'S REPRESENTATIVE, AFTER SUBGRADE IS ROUGH GRADED.
- 8. UNLESS OTHERWISE EXPRESSLY INDICATED HEREON, FINISHED GRADES ARE TO MATCH ADJACENT EXISTING GRADES.
- 9. THE GENERAL CONTRACTOR SHALL PRESERVE EXISTING VEGETATION WHERE POSSIBLE AND/OR AS NOTED ON DRAWINGS. SEE SESC PLAN ON SHEET C1.11 FOR LIMIT OF DISTURBANCE. PROTECT EXISTING TREES TO REMAIN WITH TEMPORARY FENCING PLACED AT THE DRIP LINE. NO GROUND DISTURBANCE OR STORAGE OF MATERIAL SHALL OCCUR WITHIN THE DRIP LINE LIMITS, UNLESS HEREON EXPRESSLY INDICATED OTHERWISE.
- 10. ALL EXCAVATION IS CONSIDERED UNCLASSIFIED AND THE GENERAL CONTRACTOR IS RESPONSIBLE FOR ALL MEANS, METHODS AND MATERIALS OF CONSTRUCTION TO COMPLETE THE CONSTRUCTION PER THE DRAWINGS AND PROJECT MANUAL. ADDITIONALLY, THE GENERAL CONTRACTOR IS RESPONSIBLE FOR THE OFF-SITE DISPOSAL OF EXCESS OR UNSUITABLE MATERIAL, AS WELL AS THE IMPORTATION OF ANY BORROW MATERIAL NECESSARY TO COMPLETE THE PROJECT.
- 11. ALL RETAINING WALL ELEVATIONS ARE PROVIDED FOR REFERENCE ONLY. ACTUAL ELEVATIONS SHALL BE FIELD VERIFIED AND COORDINATED WITH PROPOSED IMPROVEMENTS.

FUEL GRADING DESIGN STANDARDS:

- 1. PROVIDE POSITIVE DRAINAGE AWAY FROM FUEL CENTER CONCRETE PAD(S). PER GRADING/SECTION DRAWINGS, 1%-3% SLOPE IS TYPICAL WITH A MAXIMUM SLOPE OF 5%. UNLESS EXPRESSLY AUTHORIZED BY THE OWNER'S REPRESENTATIVE, SURFACE WATER SHALL NOT DRAIN THROUGH THE FUEL/CANOPY AREAS.
- 2. PROVIDE MAXIMUM OF 2% SLOPES/GRADES ACROSS FUEL CENTER CONCRETE PADS (UNDER CANOPY AREA), WHILE MAINTAINING POSITIVE DRAINAGE AWAY FROM THE FUEL CENTER KIOSK AND DISPENSER ISLANDS. GRADES AT TANK PAD SHALL NOT EXCEED 3% SLOPE.
- 3. SPECIAL ATTENTION IS REQUIRED AT THE DOORWAY OF THE KIOSK. IN GENERAL, THE KIOSK FINISH FLOOR IS TO BE 1" HIGHER THAN THE SURROUNDING EXTERIOR GRADE. SLOPE DRIVEWAY PAVING TO MEET THE FINISH FLOOR GRADE AT ANY DOORWAY, AND COORDINATE WITH FUEL CENTER CONTRACTOR. ADA GUIDELINES MUST BE VERIFIED FOR DOOR ENTRANCES AND FOR THE CUSTOMER SERVICE DRAWER AT THE KIOSK WINDOW.

SITE SPECIFIC GRADING GENERAL NOTES:

THE GENERAL CONTRACTOR IS RESPONSIBLE FOR THE REPAIR OF ANY EXISTING SITE IMPROVEMENTS THAT MAY BE DISTURBED DURING CONSTRUCTION. THIS SHALL INCLUDE, AND IS NOT NECESSARILY

(A) EXISTING CURB THAT MAY BE DISTURBED DURING INSTALLATION OF VENT STANDS, AIR STANDS,

(B) EXISTING ASPHALT THAT MAY BE DISTURBED DURING TANK INSTALLATION, (C) EXISTING LANDSCAPING,

(D) EXISTING LIGHT STANDARD(S) AND WIRING.

TG GUTTER GRADE

TC TOP OF CURB BW FINISHED GRADE AT WALL

FG FINISHED GRADE

DITCH FLOW LINE PUMP ISLAND BOTTOM

PUMP ISLAND TOP TP TOP OF PAVEMENT

RIM UNDERGROUND STRUCTURE RIM

TW TOP OF WALK

FFE FINISHED FLOOR ELEVATION

ME MATCH EXISTING

2.0% PROPOSED SLOPE

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734.367.4445 Telephone


Corporate Office: **4925 Forest Avenue** Downers Grove, IL 60515

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REVISIONS

NO.	DATE	DESCRIPTION
1	08.10.2017	SITE PLAN/CONDITIONAL USE

CONSULTANT

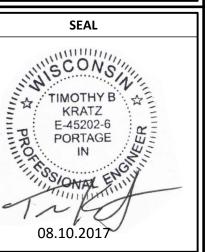

CUSTOMER

PROJECT DESCRIPTION

534-00390 **RETAIL FUEL CENTER**

PROJECT LOCATION

1750 HWY. 51 WEST STOUGHTON, WI 53589

(DANE COUNTY)


SHEET TITLE

GRADING PLAN

SHEET MANAGEMENT			
PROJECT NO.:	534-0039		
DATE:			
CAD FILE:			
PROJECT MANAGER:	T. KRAT		
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C1.30



KEYNOTES

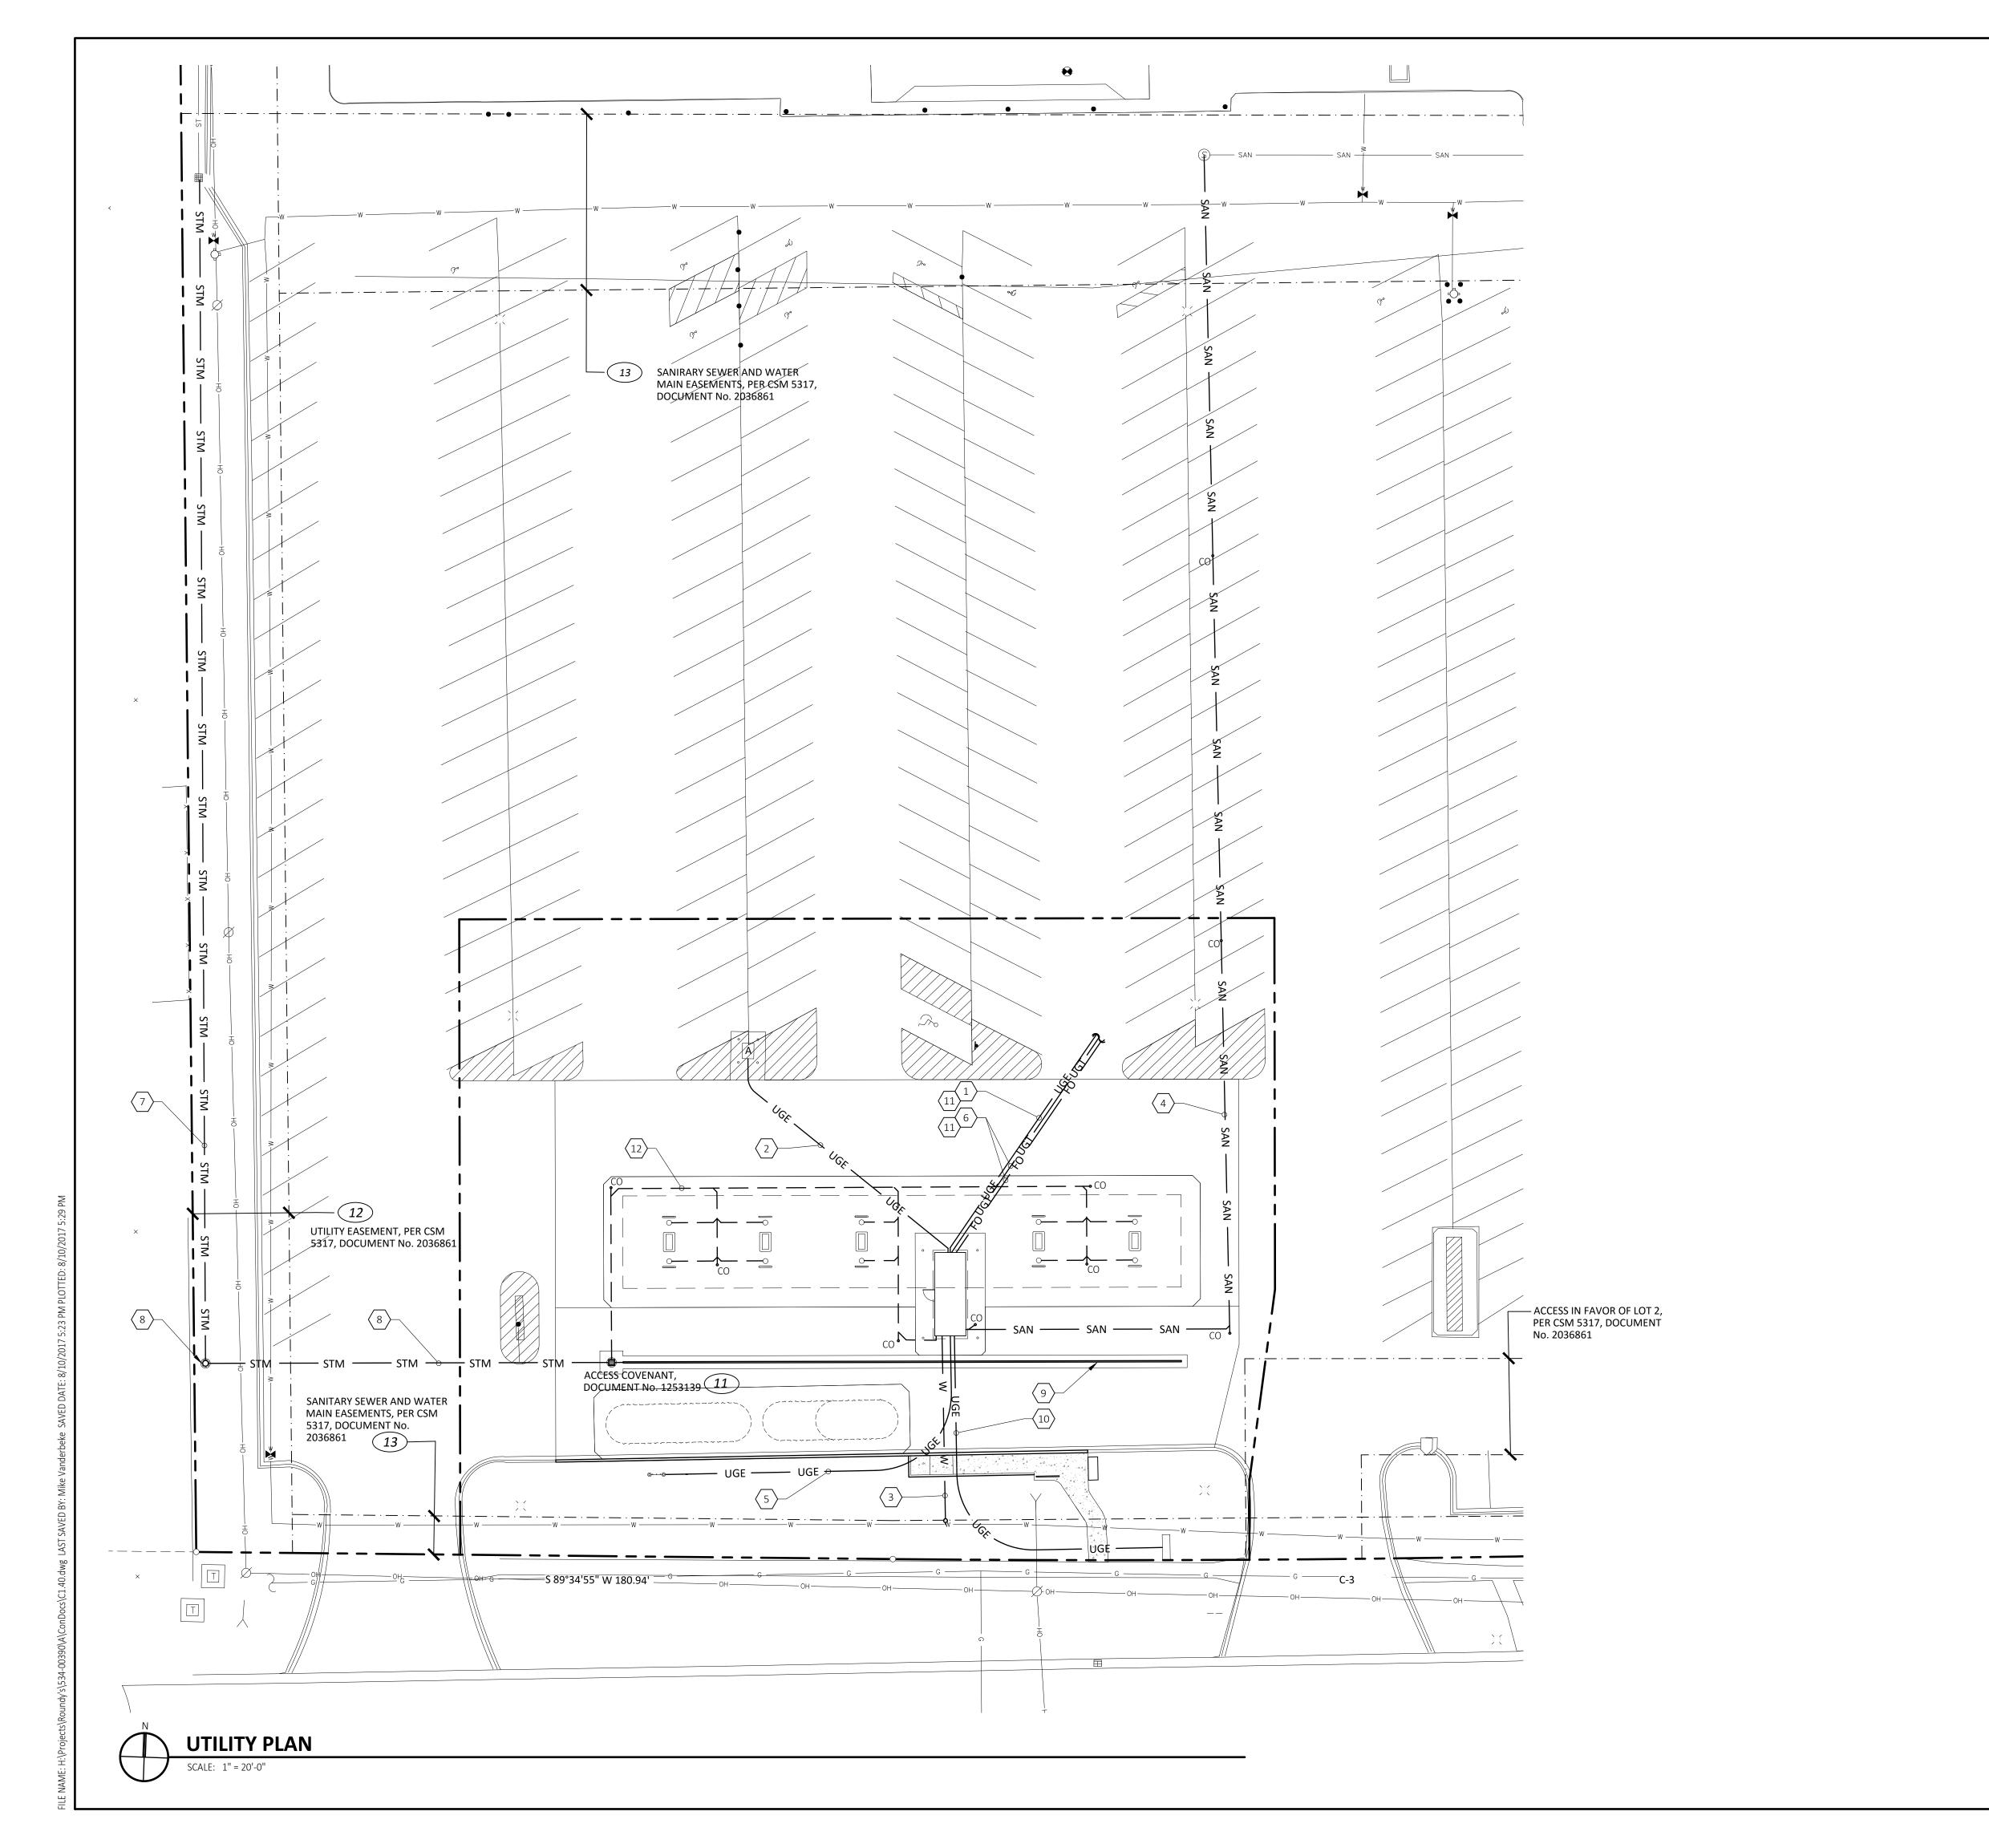- 1. PROVIDE AND INSTALL TWO (2) 4" SCHEDULE 40 PVC CONDUIT (WITH TWO (2) PULL STRINGS EACH) FROM GROCERY STORE FOR ELECTRIC SUPPLY TO THE FUEL CENTER KIOSK. UTILITY COMPANY TO PROVIDE AND PULL WIRE FROM TRANSFORMER TO SERVICE ENTRANCE AND MAKE FINAL CONNECTION. FIELD VERIFY AND COORDINATE EXACT CONDUIT ROUTING WITH OWNER'S CONSTRUCTION REPRESENTATIVE. REFER TO KIOSK POWER AND LIGHTING PLAN ON SHEET E1.0 AND THE LINE DIAGRAM(S) AND PANEL SCHEDULE(S) ON SHEET E2.0 FOR STUB-UP LOCATIONS AND ELECTRICAL LOAD REQUIREMENTS.
- 2. PROVIDE AND INSTALL ONE (1) 3/4" SCHEDULE 40 PVC CONDUIT FROM FUEL CENTER KIOSK TO AIR COMPRESSOR FOR 120V POWER.
- 3. PROVIDE AND INSTALL 3/4" PVC SDR-21, CLASS 200 WATER SERVICE LINE (MIN. DEPTH 5.0'); PROVIDE MINIMUM 18" CLEARANCE AT ALL UTILITY CROSSINGS. MAKE CONNECTION AT WATER MAIN PER REQUIRED STANDARDS.
- 4. PROVIDE AND INSTALL 6" PVC SDR-35 SANITARY SEWER SERVICE WITH CLEANOUTS LOCATED 5.0' OUTSIDE OF FOUNDATION AND AT EVERY HORIZONTAL AND VERTICAL BEND PER DETAIL 7/C5.01. MAKE CONNECTION TO SANITARY SEWER STRUCTURE PER REQUIRED STANDARDS.
- 5. PROVIDE AND INSTALL TWO (2) 3/4" SCHEDULE 40 PVC CONDUIT FROM FUEL CENTER KIOSK
- 6. INSTALL (2) 2" SCH 40 PVC COMMUNICATION CONDUITS (WITH TWO (2) PULL STRINGS EACH) FROM THE GROCERY STORE TO THE FUEL CENTER KIOSK. REFER TO ELECTRICAL PLANS AND DETAILS ON SHEET E1.0 FOR ADDITIONAL INFORMATION. COORDINATE WITH COMMUNICATION UTILITY COMPANY.
- 7. 12" HDPE PIPE.
- 8. 24" STRUCTURE.
- 9. SLOTTED DRAIN.
- 10. PROVIDE AND INSTALL TWO (2) 3/4" SCHEDULE 40 PVC CONDUITS (WITH TWO (2) PULL STRINGS EACH) FROM THE FUEL CENTER KIOSK TO EACH SITE ID SIGN WHERE FUEL PRICING WILL BE INCORPORATED. SEE ELECTRICAL PLANS AND DETAILS ON SHEETS E1.0 AND E2.0 FOR ADDITIONAL INFORMATION.
- 11. BORE CONDUITS TO STORE.
- 12. ROOF DRAINS.

LEGEND:

EXISTING STRUCTURES:

■ GOVERNMENT CORNER 1" IRON PIPE FOUND CHISELED 'X' FOUND 3/4" x 24" REBAR SET (1.50 LBS/LF) CONTROL POINT **BENCHMARK** FINISHED FLOOR SHOT LOCATION BOLLARD MAIL BOX

SIGN SANITARY MANHOLE HYDRANT WATER OR GAS VALVE STORM MANHOLE

SQUARE CASTED INLET ■ CURB INLET ENDWALL/END OF PIPE DOWNSPOUT GAS REGULATOR/METER

☐ LIGHT POLE TELEPHONE PEDESTAL DECIDUOUS TREE TR TOP OF RAMP

CONIFEROUS TREE HANDICAP PARKING BOTTOM OF RAMP TS **TOP OF STEPS**

BS **BOTTOM OF STEPS**

PROPOSED STRUCTURES: STORM MANHOLE

> CATCH BASIN YARD BASIN FLARED END SECTION SANITARY MANHOLE SANITARY CLEANOUT

LIGHT POLE WATER VALVE FIRE HYDRANT

— – – PARCEL BOUNDARY

— — — RIGHT-OF-WAY LINE

— – – – SECTION LINE

---- CENTERLINE

—x——x— FENCE LINE

····· CHORD LINE

---- PLATTED LOT LINE — · — · — EASEMENT LINE

GUARD OR SAFETY RAIL

----- EDGE OF PAVEMENT

—— SAN —— SANITARY SEWER

——w—— WATER LINE

— ST — STORM SEWER

——— G — NATURAL GAS

<u>////////</u> BUILDING

—— 875 — INDEX CONTOUR

—— OH — OVERHEAD ELECTRIC

— E — UNDERGROUND ELECTRIC

----874 --- INTERMEDIATE CONTOUR

\$10.29 SPOT ELEVATION

CONCRETE PAVEMENT

O DISCONTINUED MAPPED PIPE LINE

() DENOTES RECORD DATA DEPICTING THE

RETRACED BY THIS SURVEY

TRANSFORMER

AIR TOWER

SAME LINE ON THE GROUND AS

· STONE RETAINING WALL

CONCRETE CURB & GUTTER

LINETYPES: — STM — STORM SEWER

ROOF DRAIN SANITARY SEWER WATER MAIN/SERVICE GAS MAIN/SERVICE

ELECTRIC SERVICE TELEPHONE SERVICE OVERHEAD UTILITIES

 \longrightarrow STM \longrightarrow

PROPOSED UTILITIES BY OTHERS

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Corporate Office:

4925 Forest Avenue

Downers Grove, IL 60515

SAFETY - INTEGRITY - SUSTAINABIL

REVISIONS O. DATE DESCRIPTION 08.10.2017 SITE PLAN/CONDITIONAL USE

CONSULTANT

KRATZ **PORTAGE**

CUSTOMER

Pick 'n Save'

PROJECT DESCRIPTION

534-00390 **RETAIL FUEL CENTER**

PROJECT LOCATION

1750 HWY. 51 WEST STOUGHTON, WI 53589

(DANE COUNTY)


SHEET TITLE

UTILITY PLAN

SHEET MANAGEMENT C1.40.dwg PROJECT MANAGER:


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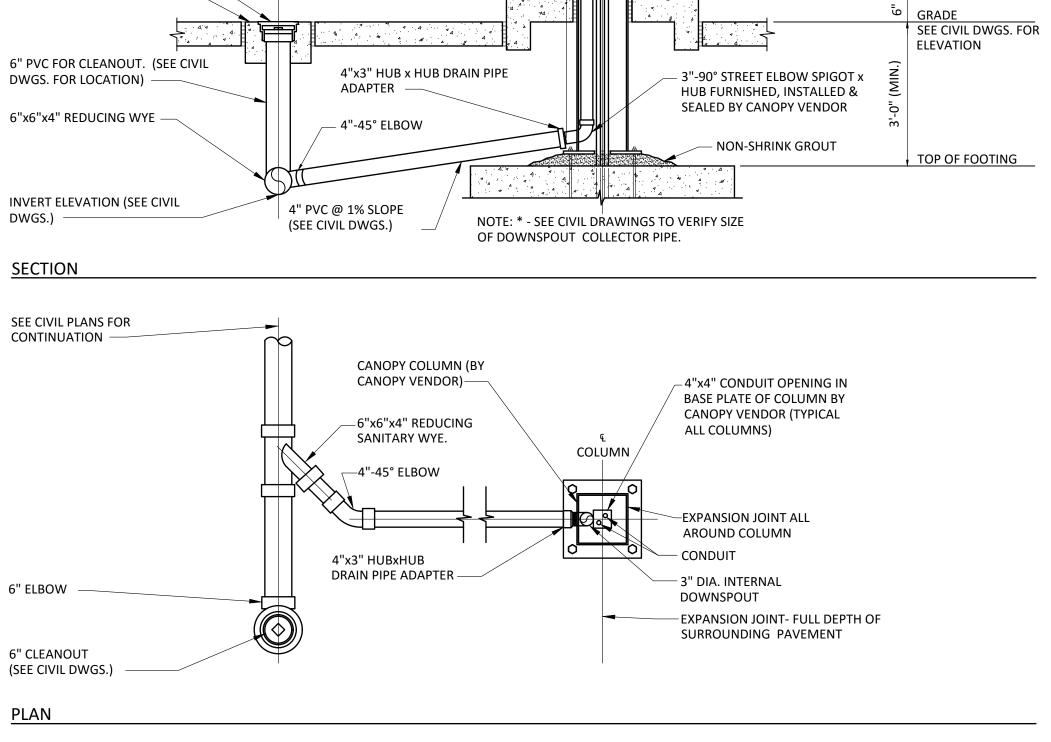
C1.40

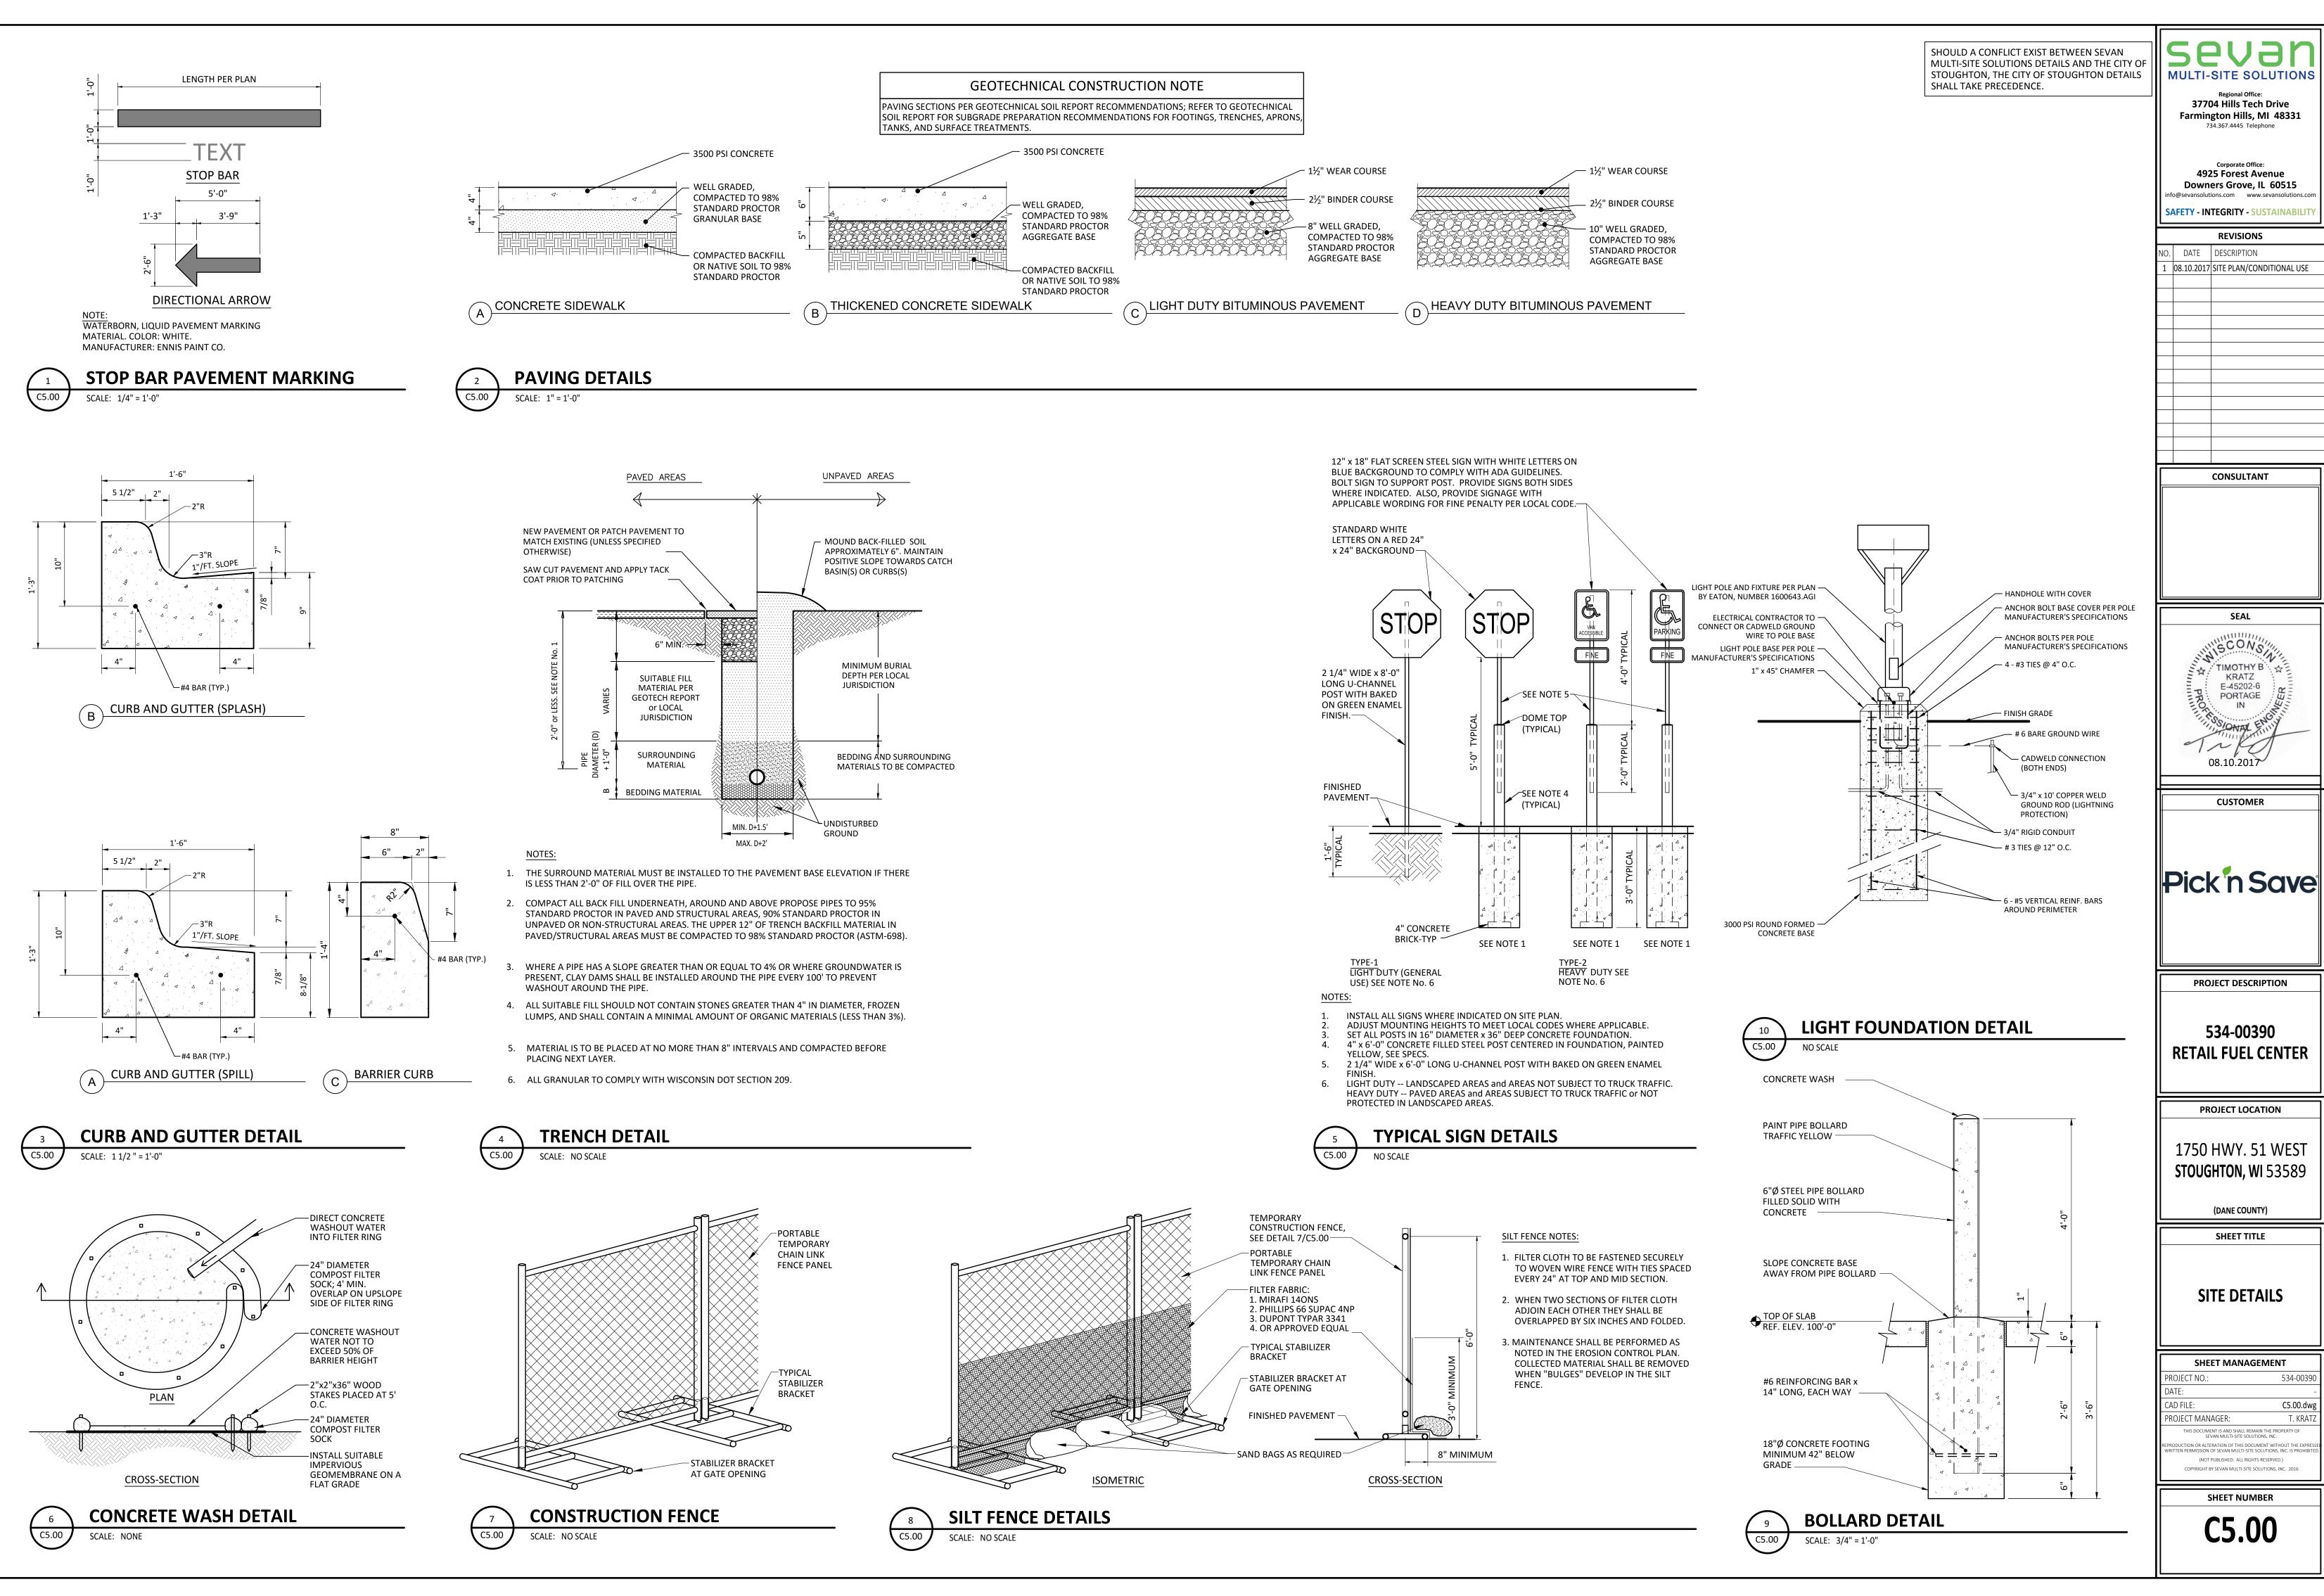


C5.00.dwg

T. KRAT



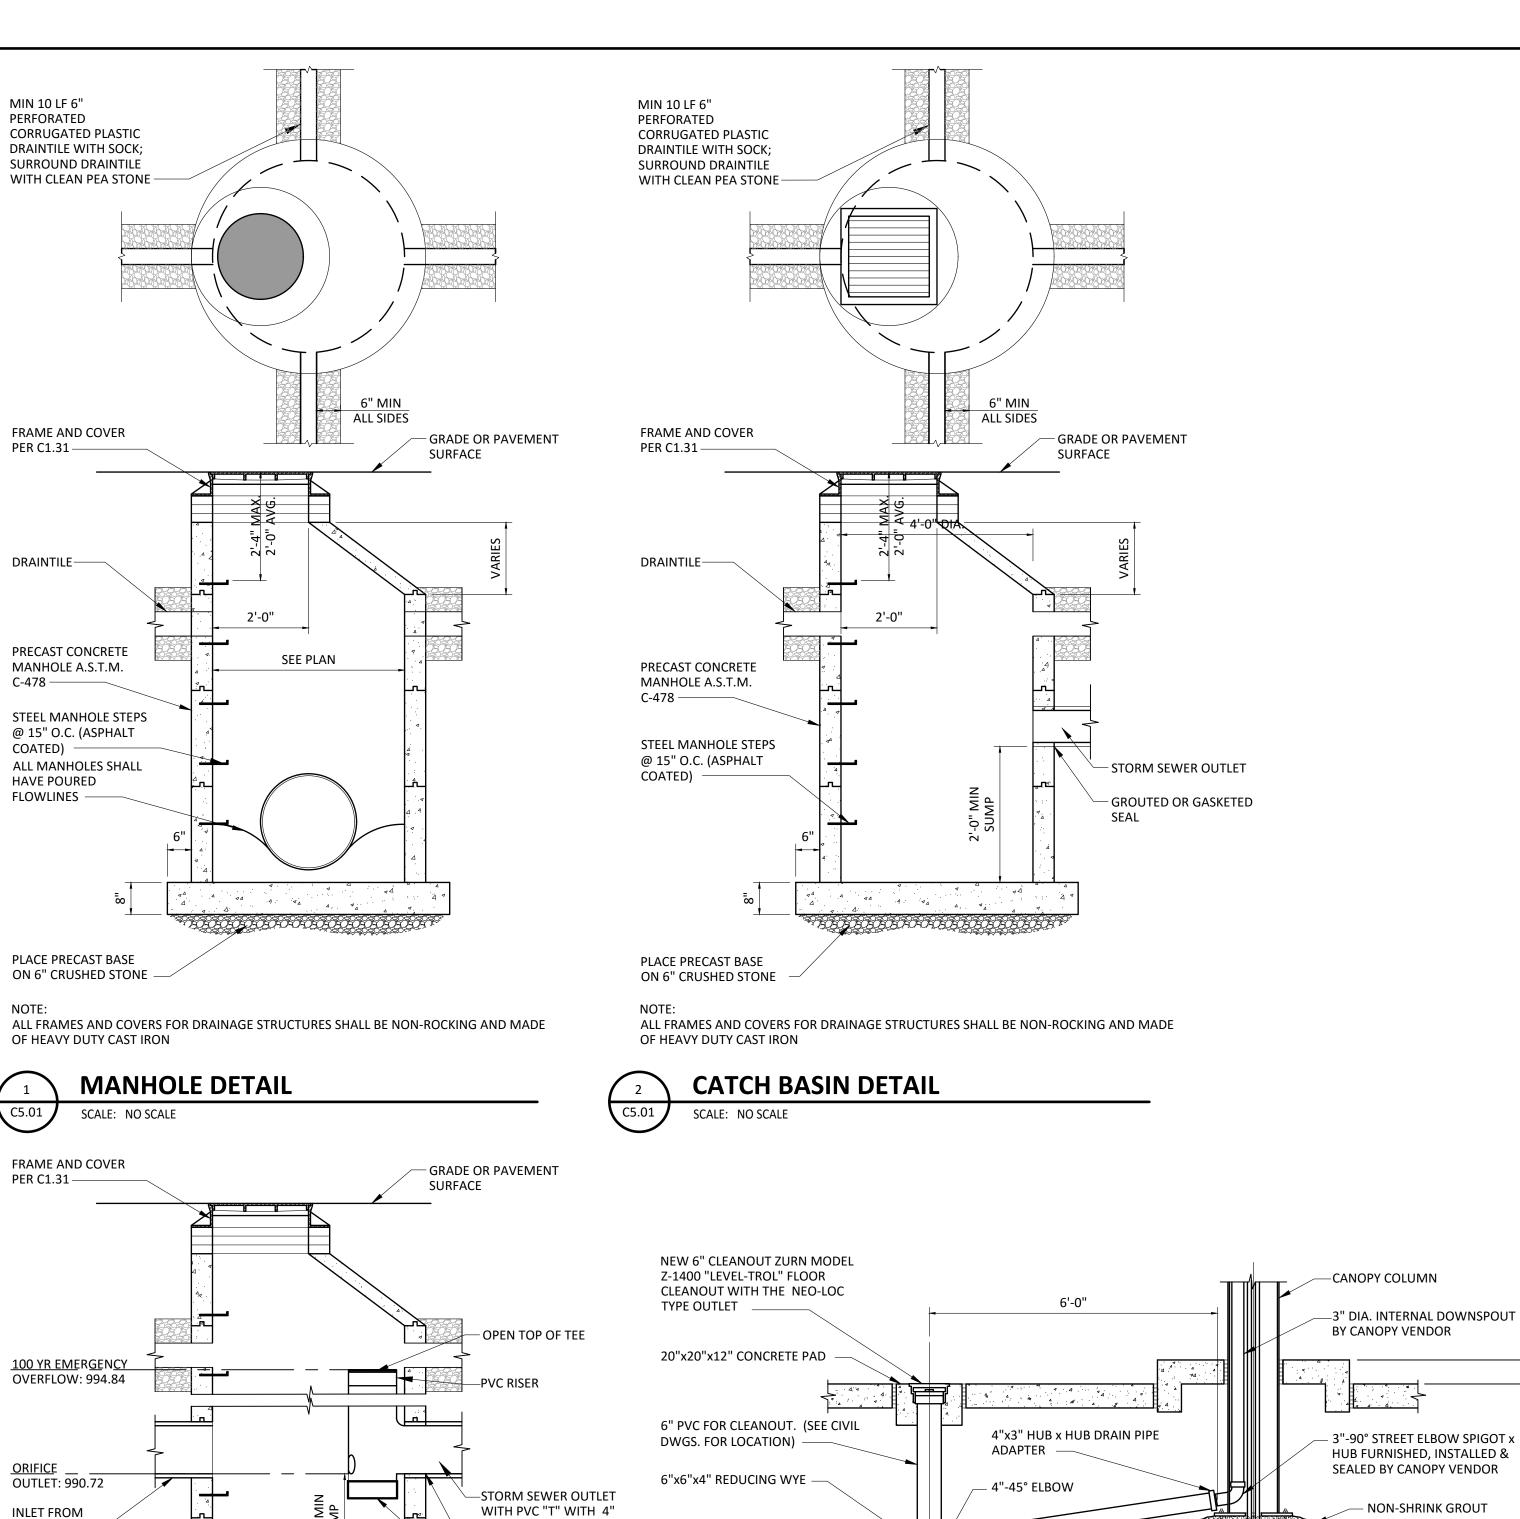

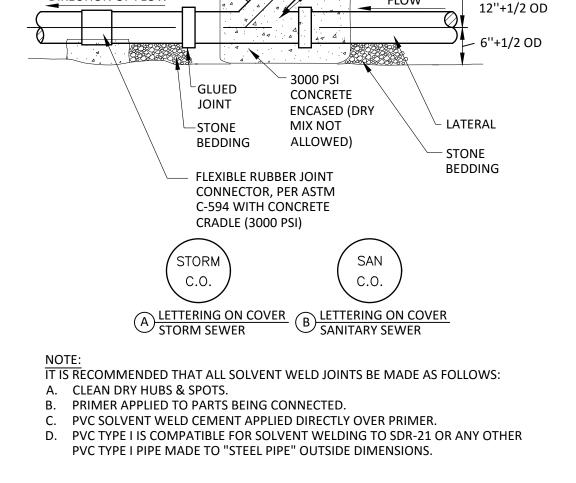

FOR TRAFFIC AREA ASSEMBLY DETAIL

ASPHALT OR CONCRETE AS

DWV PVC WYE ASTM D-2665 SCH.

80 (TEES NOT ALLOWED) 6" X 6" X

CLEAN-OUT

6" OR 6" X 6" WITH 4" REDUCING

BRANCH AS REQUIRED -

DIRECTION OF FLOW

DETERMINED BY TRAFFIC

3,000 PSI

CONCRETE-

GLUED JOINT-

TOP OF ISLAND

18" SQUARE CAST IRON/DUCTILE

IRON CLEANOUT

COVER, SEE COVER

LETTERING BELOW

- PROVIDE RUBBER

FINISHED GRADE

- LATERAL RISER PVC SCH. 80

(ASTM D-2665)

─WYE FITTINGS

ALLOWED

ONLY TEES NOT

FLOW

4"OR 6" 45° 1/8 LONG

SWEEP BEND STREET. ALL

PVC SCH. 80 (ASTM D-2665)

COMPACTED

"SELECT

FILL" MIN.

GASKET

LENGTH AS SPECIFIED FERNCO COUPLING ON PLANS. EXCAVATE AS REQUIRED AND PROVIDE SUPPORT TO PREVENT DEFELCTION -6" BEDDING STONE (MINIMUM) MAIN SEWER

MINIMUM

STORM/SANITARY **SEWER CROSSING DETAIL** C5.01 SCALE: NO SCALE

SANITARY SEWER STORM SEWER Pick 'n Save MINIMUM JOINTS **EQUIDISTANT** FROM SEWER -LATERAL OR MAIN SEWER

SHOULD A CONFLICT EXIST BETWEEN SEVAN

DETAILS SHALL TAKE PRECEDENCE.

MULTI-SITE SOLUTIONS DETAILS AND THE CITY OF

STOUGHTON DETAILS, THE CITY OF STOUGHTON

MULTI-SITE SOLUTIONS

37704 Hills Tech Drive

Farmington Hills, MI 48331

734.367.4445 Telephone

Corporate Office: 4925 Forest Avenue Downers Grove, IL 60515

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CONSULTANT

SEAL

TIMOTHY B

KRATZ

E-45202-6 PORTAGE

CUSTOMER

PROJECT DESCRIPTION

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RETAIL FUEL CENTER

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1750 HWY. 51 WEST

STOUGHTON, WI 53589

(DANE COUNTY)

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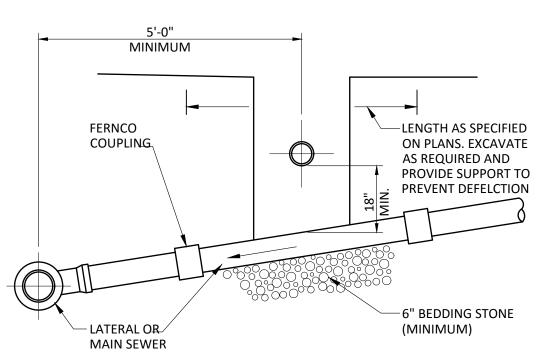
SITE DETAILS

SHEET MANAGEMENT

EQUIDISTANT

FROM SEWER

MINIMUM



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C5.01

CONCRETE COLLAR DETAIL SCALE: NO SCALE

4 4 4 4 4 4 4 4

OUTLET CONTROL STRUCTURE

INLET FROM

DETENTION —

MANHOLE PER

DETAIL 1/C5.01

SCALE: NO SCALE

STANDARD MANHOLE CASTING

8" CONCRETE COLLAR

WIRE MESH

COMPACTED

SUBGRADE -

6" COMPACTED

AGGREGATE BASE-

6x6-W1.4xW1.4 —

C5.00

CORED ORIFICES

BITUMINOUS

PAVEMENT

2'-0" MIN.

SLOPE 0.10' FROM
ASPHALT TO CASTING

_CONCRETE

RINGS)

ADJUSTMENT RINGS


(MIN. 6" OF RISER

- GROUTED OR GASKETED


CAP BOTTOM OF TEE

DOWNSPOUT CONNECTION TO STORM LINE DETAIL

EXISTING LANDSCAPE REMOVAL PLAN

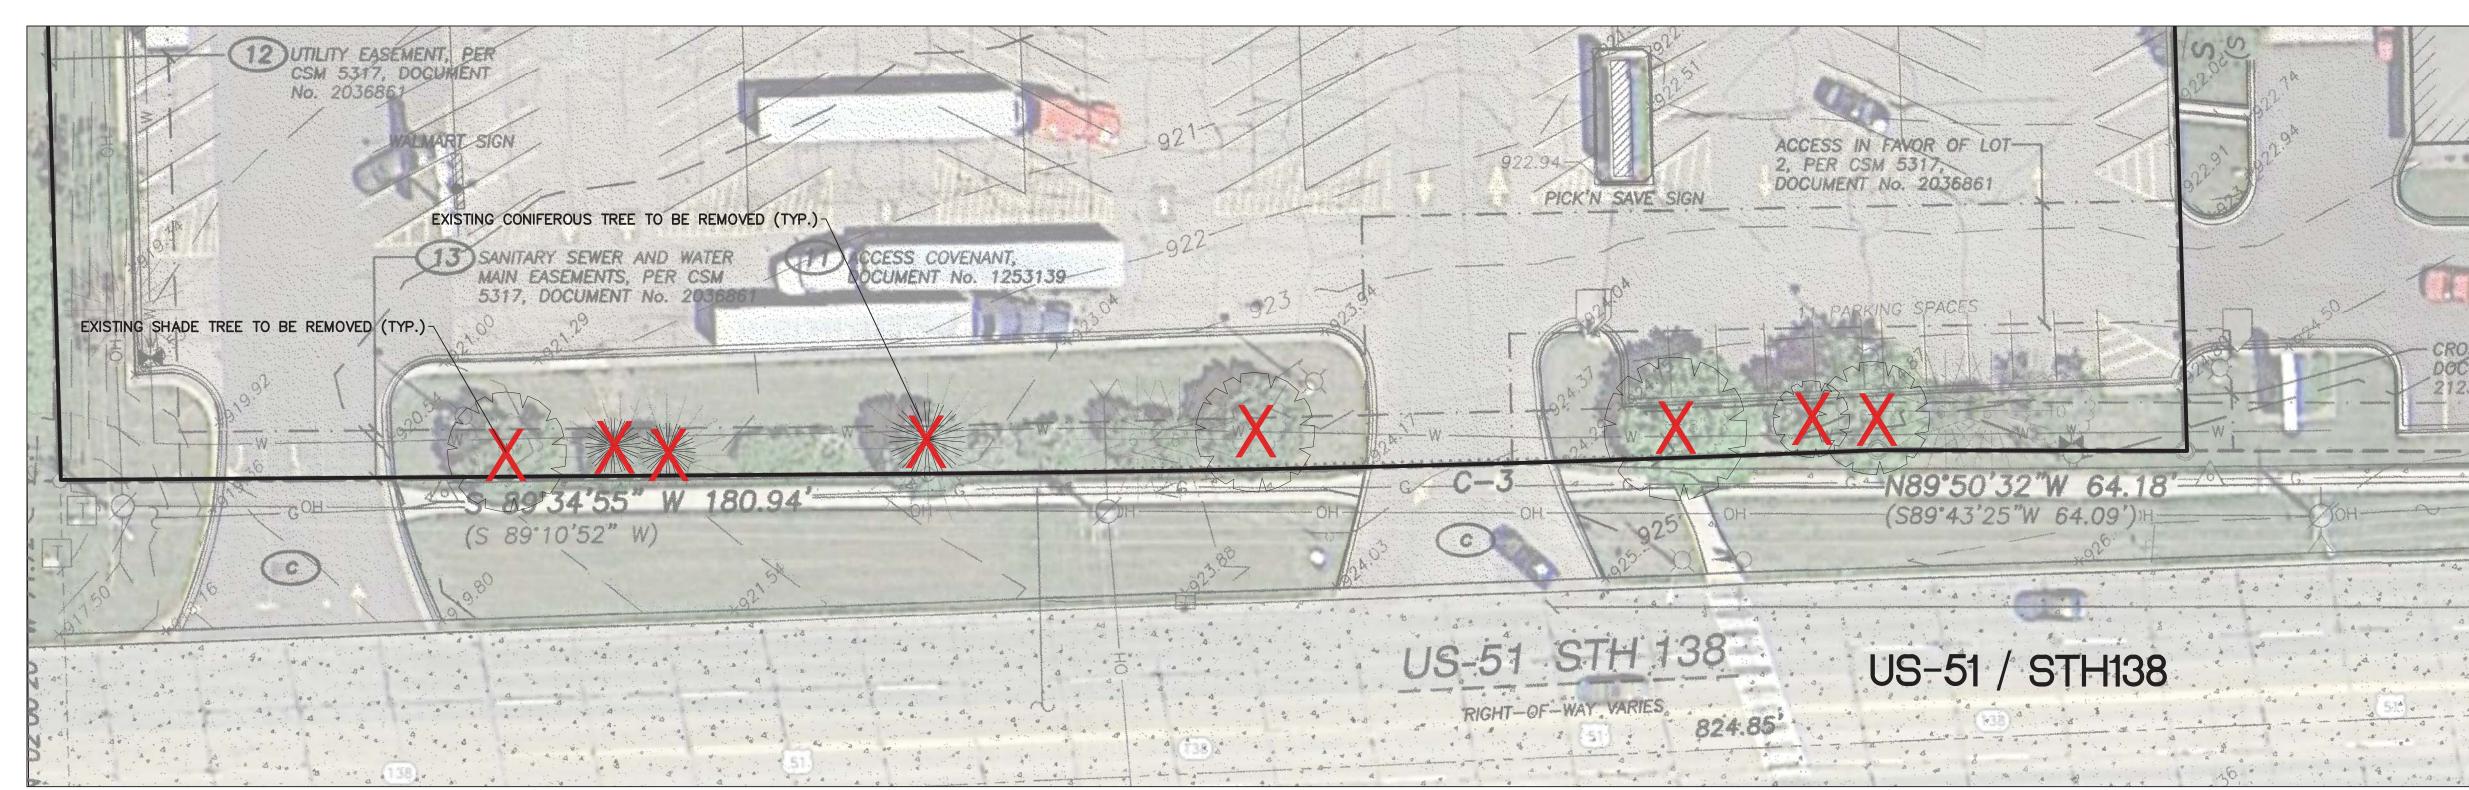


PROPOSED LANDSCAPE PLAN

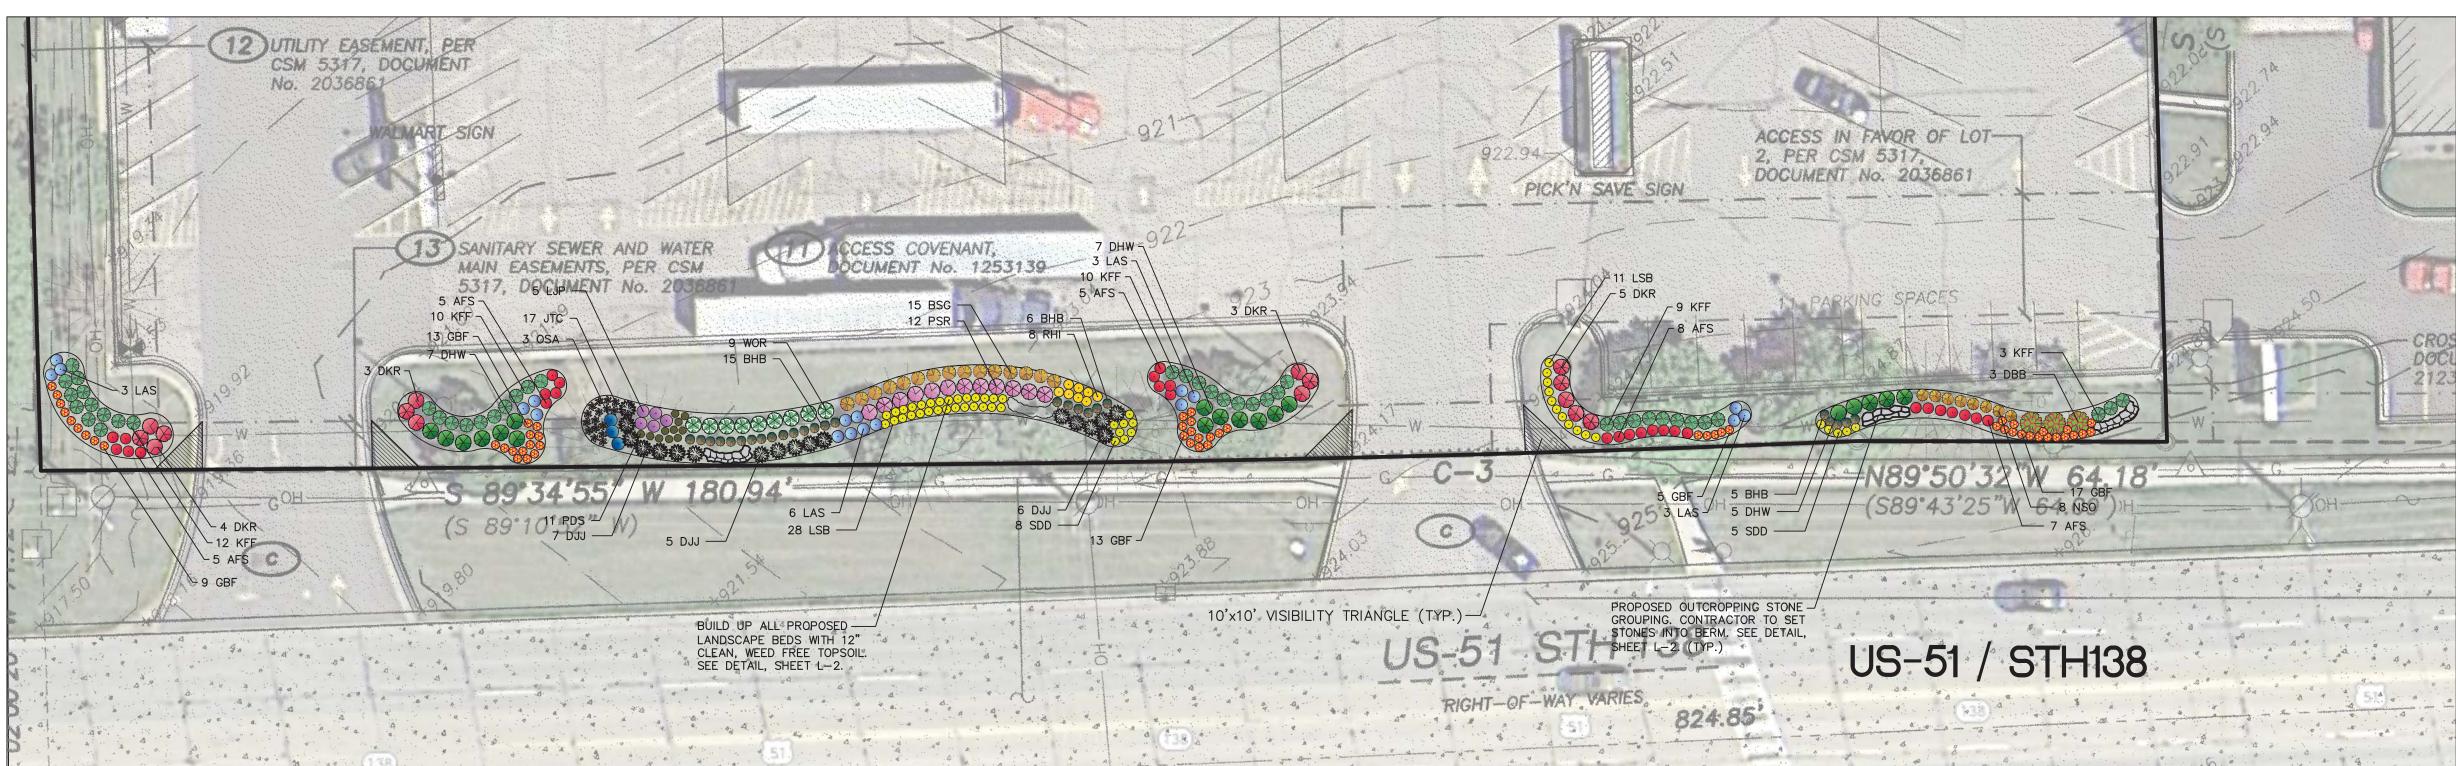

THESE PLANS ARE BASED ON THE ALTA/ACSM LAND TITLE SURVEY, SURVEY PROJECT #14-6271 DATED 6-24-14 PREPARED BY: JDS PROFESSIONAL SERVICES INC. 161 HORIZON DRIVE, SUITE 101

(608) 848-5060
2. PRIOR TO CONSTRUCTION, CONTRACTOR TO CONTACT THE DESIGN ENGINEER AND ARCHITECT TO VERIFY THAT THEY ARE WORKING FROM THE MOST CURRENT SET OF PLANS AND SPECIFICATIONS.

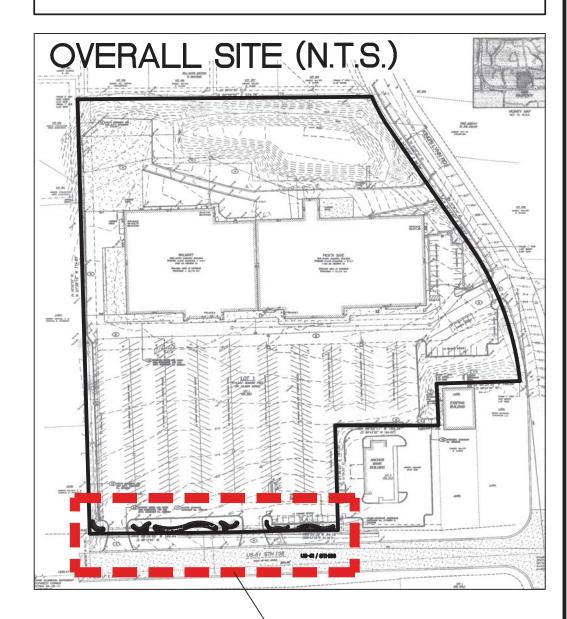

LANDSCAPE PLAN AREA

Prepared For:

Prepared By:


PLANT LIST

FLOW	ERING	AND EVERGREEN SHRUBS		
QTY.	ABRV.	BOTANICAL NAME	COMMON NAME	SIZE
3	DBB	Euonymus alatus 'Compactus'	Dwarf Burning Bush	5 Ga
15	DKR	Rosa 'Radtko'	Double Knock Out Rose	3 Ga
9	WOR	Rosa 'Radwhite'	White Out Rose	3 Ga
12	PSR	Rosa var. 'NOA168098F'	Pink Supreme Carpet Rose	3 Ga
19	DHW	Weigela x 'Dark Horse'	Dark Horse Weigela	3 Ga
18	DJJ	Juniperus procumbens 'Nana'	Dwarf Japgarden Juniper	5 Ga

PERENNIALS, ORNAMENTAL GRASS AND GROUNDCOVERS					
QTY.	ABRV.	BOTANICAL NAME	COMMON NAME	SIZE	
8	NSO	Chasmanthium latifolium	Northern Sea Oats	1 Gal.	
16	JTC	Coreopsis 'Jethro Tull'	Jethro Tull Coreopsis	1 Gal.	
5	LJP	Eupatorium dubium 'Little Joe'	Little Joe Dwarf Joe Pye Weed	1 Gal.	
57	GBF	Gaillardia grandiflora 'Goblin'	Goblin Blanket Flower	1 Gal.	
13	SDD	Hemerocallis 'Stella de' Oro	Stella de Oro Daylily	1 Gal.	
15	BSG	Panicum virgatum 'Heavy Metal'	Blue Switch Grass	1 Gal.	
18	LAS	Perovskia atriplicifolia 'Lisslitt'	Lacey Blue Sage	1 Gal.	
39	LSB	Rudbeckia fulgida 'Viette's Little Suzy'	Little Suzy Black Eyed Susan	1 Gal.	
8	RHI	Rudbeckia hirta	Black Eyed Susan	1 Gal.	
30	AFS	Sedum spectabile 'Autumn Fire'	Autumn Fire Sedum	1 Gal.	
3	OSA	Symphyotrichum oolentangiense	October Sky Aromatic Aster	1 Gal.	
44	KFF	Calamagrostis x acutiflora 'Karl Foerster'	Karl Foerster Feather Reed Grass	1 Gal.	
26	ВНВ	Schizachyrium scoparius 'MinnblueA'	Blue Heaven Little Bluestem	1 Gal.	
11	PDS	Sporobolus heterolepis	Prairie Dropseed	1 Gal.	





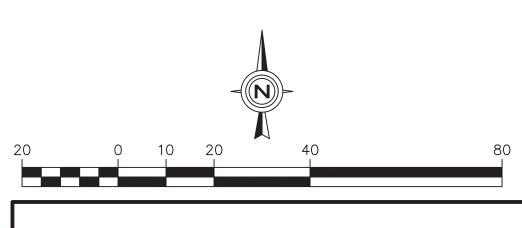


LANDSCAPE PLAN


L-1


LANDSCAPE NOTES

- 1. ALL PLANT MATERIAL SHALL BE HARDY TO THE ZONE IT IS BEING PLANTED IN. ALL TREES AND SHRUBS ARE TO BE BALLED AND BURLAPED UNLESS OTHERWISE NOTED AND SHALL BE GROWN IN ACCORDANCE WITH THE STANDARDS SET FORTH BY THE LATEST EDITION OF AMERICAN STANDARD FOR NURSERY STOCK PUBLISHED BY AMERICANHORT.
- 2. PLANT SIZES CALLED OUT ON THIS PLAN ARE THE MINIMUM SIZE REQUIRED. PLANTS WHICH FAIL TO MEET THE SIZES LISTED, SHALL BE REJECTED AT THE EXPENSE OF THE CONTRACTOR.
- 3. CONTRACTOR MUST VERIFY ALL MATERIAL QUANTITIES AS DEPICTED ON THE DRAWING. THE PLANT LIST PROVIDED ON THIS PLAN IS FOR CONVENIENCE ONLY.
- 4. SUBSTITUTIONS MAY NOT BE MADE WITHOUT THE APPROVAL OF THE LANDSCAPE ARCHITECT/DESIGNER.
- 5. THE CONTRACTOR SHALL NOTIFY ALL APPROPRIATE AGENCIES AND UTILITY LOCATORS PRIOR TO CONSTRUCTION. CONTRACTOR SHALL NOT BEGIN ANY WORK ON—SITE UNTIL ALL UTILITIES HAVE BEEN LOCATED. CONTRACTOR SHALL OBTAIN "AS—BUILT" PLANS FOR ALL IRRIGATION AND LIGHTING PRIOR TO CONSTRUCTION.
- 6. CONTRACTOR IS RESPONSIBLE FOR PROTECTING ALL UTILITIES INCLUDING IRRIGATION AND LIGHTING. ALL DAMAGE SHALL BE REPAIRED TO A NEW CONDITION IN ACCORDANCE WITH ALL CODES AT NO COST TO THE OWNER SEE NOTE 5.
- 7. ALL UNSUITABLE MATERIAL (CONCRETE, AGGREGATE STONE, CRUSHED ASPHALT, BRICK ETC.) SHALL BE REMOVED, INCLUDING HAUL OFF, PRIOR TO PLANTING AND SHALL BE THE RESPONSIBILITY OF THE LANDSCAPE CONTRACTOR.
- 8. SOIL MIX PM35 BY MIDWEST TRADING COMPANY OR EQUAL SHALL BE ROTOTILLED INTO ALL PERENNIAL AND ANNUAL PLANTING BEDS PRIOR TO THE INSTALLATION OF THE PLANT MATERIAL. A SLOW RELEASE, GRANULAR FERTILIZER SHALL BE APPLIED TO ALL ANNUAL AND PERENNIAL PLANTING BEDS AT THE RECOMMENDED RATE, AND SHALL BE ROTOTILLED IN WITH THE ABOVE SOIL MIXTURE BEFORE THE PLANT MATERIAL IS INSTALLED.
- 9. CONTRACTOR TO PROVIDE THOROUGH INITIAL WATERING OF ALL PLANTINGS WITHIN 12 HOURS OF INSTALLATION TO ENSURE ALL AIR POCKETS HAVE BEEN REMOVED AROUND ROOT BALL.
- 10. ALL PLANT BED AREAS ARE TO BE MULCHED WITH 3" OF DOUBLE SHREDDED HARDWOOD MULCH AND SHALL BE SEPARATED WITH A SPADE EDGE ALONG PERIMETERS ADJACENT TO TURF AREAS. FINAL GRADE (AFTER SETTLING) SHALL BE 1" BELOW ADJACENT CURBS.
- 11. ALL TURF AREAS ARE TO BE A MINIMUM OF A FIVE WAY BLUEGRASS BLEND, UNLESS OTHERWISE NOTED. CONTRACTOR IS RESPONSIBLE FOR WATERING ALL INSTALLED TURF AREAS UNTIL TIME OF KNITTING. IF TURF SEED AND SOD OCCUR ON THE SAME PROJECT, CONTRACTOR SHALL VERIFY AND USE SEED MIXTURES TO MATCH SOD.
- 12. AREAS TO BE SODDED SHALL BE WITH AN "APPROVED TURFGRASS SOD" OF PREMIUM GRADE. SOD SHALL BE A 5 WAY BLEND OF IMPROVED KENTUCKY BLUEGRASS VARIETIES THAT HAS BEEN GROWN LOCALLY TO THE PROJECT SITE. SOD MUST BE MATURED FOR 2 FULL GROWING SEASONS PRIOR TO HARVEST CUTTING AND BE HEALTHY WITH WELL ESTABLISHED ROOTS. SOD SHALL BE FREE OF DISEASE, INSECTS AND DEBRIS. SOD SHALL BE UNIFORM IN LEAF COLOR, TEXTURE, AND DENSITY. SOD SHALL BE DELIVERED, INSTALLED, AND WATERED WITHIN 24 HOURS OF HARVEST IN WHICH TEMPERATURES DO NOT EXCEED 90 DEGREES (F) NOR LESS THAN 55 DEGREES (F). SOD SHALL BE MACHINE—CUT AT A MINIMUM UNIFORM SOIL THICKNESS (1.5" OF SOD IS DESIRED) BUT SOD THICKNESS SHALL BE A THICKNESS NECESSARY FOR PLANT VIABILITY. SOD SHALL BE LAID IN STAGGERED STRAIGHT LINES, TIGHTLY AGAINST EACH OTHER WITHOUT STRETCHING OR OVERLAPPING. SOD STAKES SHALL USED ON ALL SLOPES 4:1 OR GREATER.
- 13. CONTRACTOR SHALL REPAIR ALL DISTURBED AREAS (INTENDED OR UNINTENDED) AT A MINIMUM, TO THE ORIGINAL CONDITION UNLESS OTHERWISE NOTED.
- 14. THE EXISTING PLANT MATERIAL SHOWN ON THIS PLAN IS INTENDED SOLELY TO IDENTIFY THEM AS OBSERVED IN THE FIELD. THIS PLAN DOES NOT MAKE ANY CLAIMS ABOUT THE CONDITION OR SAFETY OF ANY OF THE PLANT MATERIAL DESCRIBED HEREIN OR OBSERVED IN THE FIELD.
- 15. ALL TRANSPLANTED PLANT MATERIAL MUST BE INSTALLED IMMEDIATELY UPON EXTRACTION FROM IT'S ORIGINAL LOCATION, UNLESS SPECIFIC ARRANGEMENTS HAVE BEEN MADE WITH THE LANDSCAPE ARCHITECT/DESIGNER. SHOULD IT BECOME UNREASONABLE TO TRANSPLANT ANY OF THE PLANT MATERIAL AS DESCRIBED IN THIS PLAN, DUE TO SITE CONSTRAINTS OR OTHERWISE, CONTRACTOR IS RESPONSIBLE FOR CONTACTING LANDSCAPE ARCHITECT/DESIGNER TO MAKE ALTERNATIVE ARRANGEMENTS.
- 16. THE CONTRACTOR SHALL BE RESPONSIBLE FOR MAINTAINING THE HEALTH AND VIABILITY OF THE PROPOSED PLANT MATERIAL INCLUDING WATERING, PROTECTION FROM PHYSICAL DAMAGE FROM THE TIME PLANT IS SELECTED THROUGH IT'S INSTALLATION.
- 17. CONTRACTOR IS RESPONSIBLE FOR ALL PLANT MATERIAL REMAINING PLUMB UNTIL THE END OF THE GUARANTEE PERIOD. PLANTS MAY NOT BE STAKED UNLESS APPROVED BY THE LANDSCAPE ARCHITECT/DESIGNER.
- 18. CONTRACTOR TO GUARANTEE PLANT MATERIAL AND LABOR FOR A MINIMUM OF ONE YEAR FROM THE TIME OF INSTALLATION.
- 19. THE CONTRACTOR IS RESPONSIBLE FOR BECOMING FAMILIAR WITH AND ABIDING BY THE LANDSCAPE ORDINANCES FOR THE SPECIFIC JURISDICTION IN WHICH THE WORK IS TAKING
- 20. BIDDERS SHALL BE RESPONSIBLE FOR EXAMINING THE SITE, PRIOR TO PREPARING BID, TO BECOME FAMILIAR WITH THE SPECIFIC SITE CONSTRAINTS.
- 21. ALL EXISTING ON—SITE PLANT MATERIAL NOT EFFECTED BY CONSTRUCTION OR THE PROPOSED LANDSCAPE, SHALL BE BE PROTECTED AS PART OF THIS PLAN. EXISTING LANDSCAPE IN AREAS OF CONSTRUCTION AND PROPOSED LANDSCAPE SHALL BE REMOVED AS PART OF THIS
- 22. THE CONTRACTOR SHALL FURNISH ALL LABOR, MATERIALS AND EQUIPMENT NECESSARY FOR THE COMPLETION OF ALL THE ITEMS SHOWN ON THE PLANS.
- 23. IF IRRIGATION IS DEEMED NECESSARY, THE DESIGN AND INSTALLATION OF THE IRRIGATION SYSTEM SHALL BE THE RESPONSIBILITY OF THE LANDSCAPE CONTRACTOR. AN IRRIGATION PLAN ALONG WITH AN AS BUILT OF THE IRRIGATION SYSTEM SHALL BE PREPARED FOR OWNER REVIEW AND APPROVAL. CONTRACTOR SHALL GUARANTEE PERFORMANCE, PARTS, AND LABOR FOR A PERIOD OF 1 YEAR FROM THE DATE OF FINAL APPROVAL.
- 24. IF EXISTING IRRIGATION IS PRESENT ON SITE, CONTRACTOR SHALL ADJUST, ADD TO, OR SUBTRACT FROM, THE EXISTING IRRIGATION SYSTEM TO ACCOMMODATE ANY PROPOSED ALTERATIONS/ADDITIONS TO THE EXISTING LANDSCAPE. CONTRACTOR SHALL PROVIDE THE OWNER AN AS BUILT OF THE IRRIGATION SYSTEM AND ALL CHANGES TO THE SYSTEM AFFECTED BY THIS PROJECT.
- 25. PROVIDE TOPSOIL RE-SPREAD PER THE FOLLOWING UNLESS OTHERWISE NOTED:
- A. 4" MINIMUM IN GRASS OR SOD AREAS
- B. 6" MINIMUM IN PLANTING AREASC. 12" MINIMUM IN LANDSCAPE ISLANDS

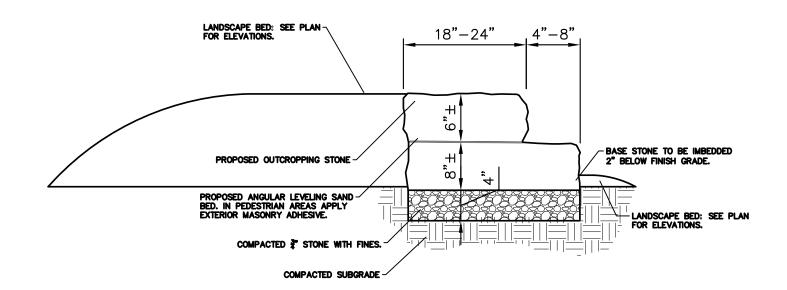

"LANNON WEATHERED EDGE" OUTCROPPING STONE DETAIL

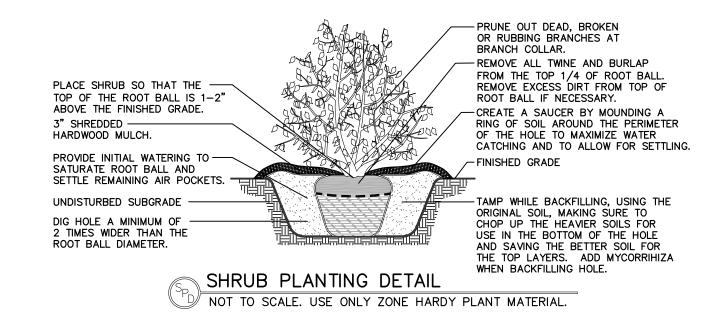

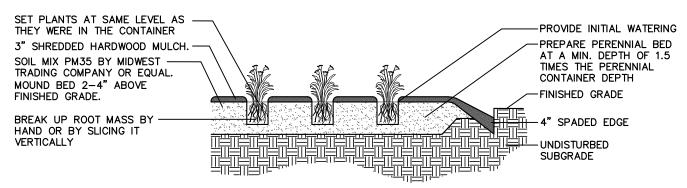


PERENNIAL PLANTING DETAIL

NOT TO SCALE. USE ONLY ZONE HARDY PLANT MATERIAL.

GENERAL NOTES:


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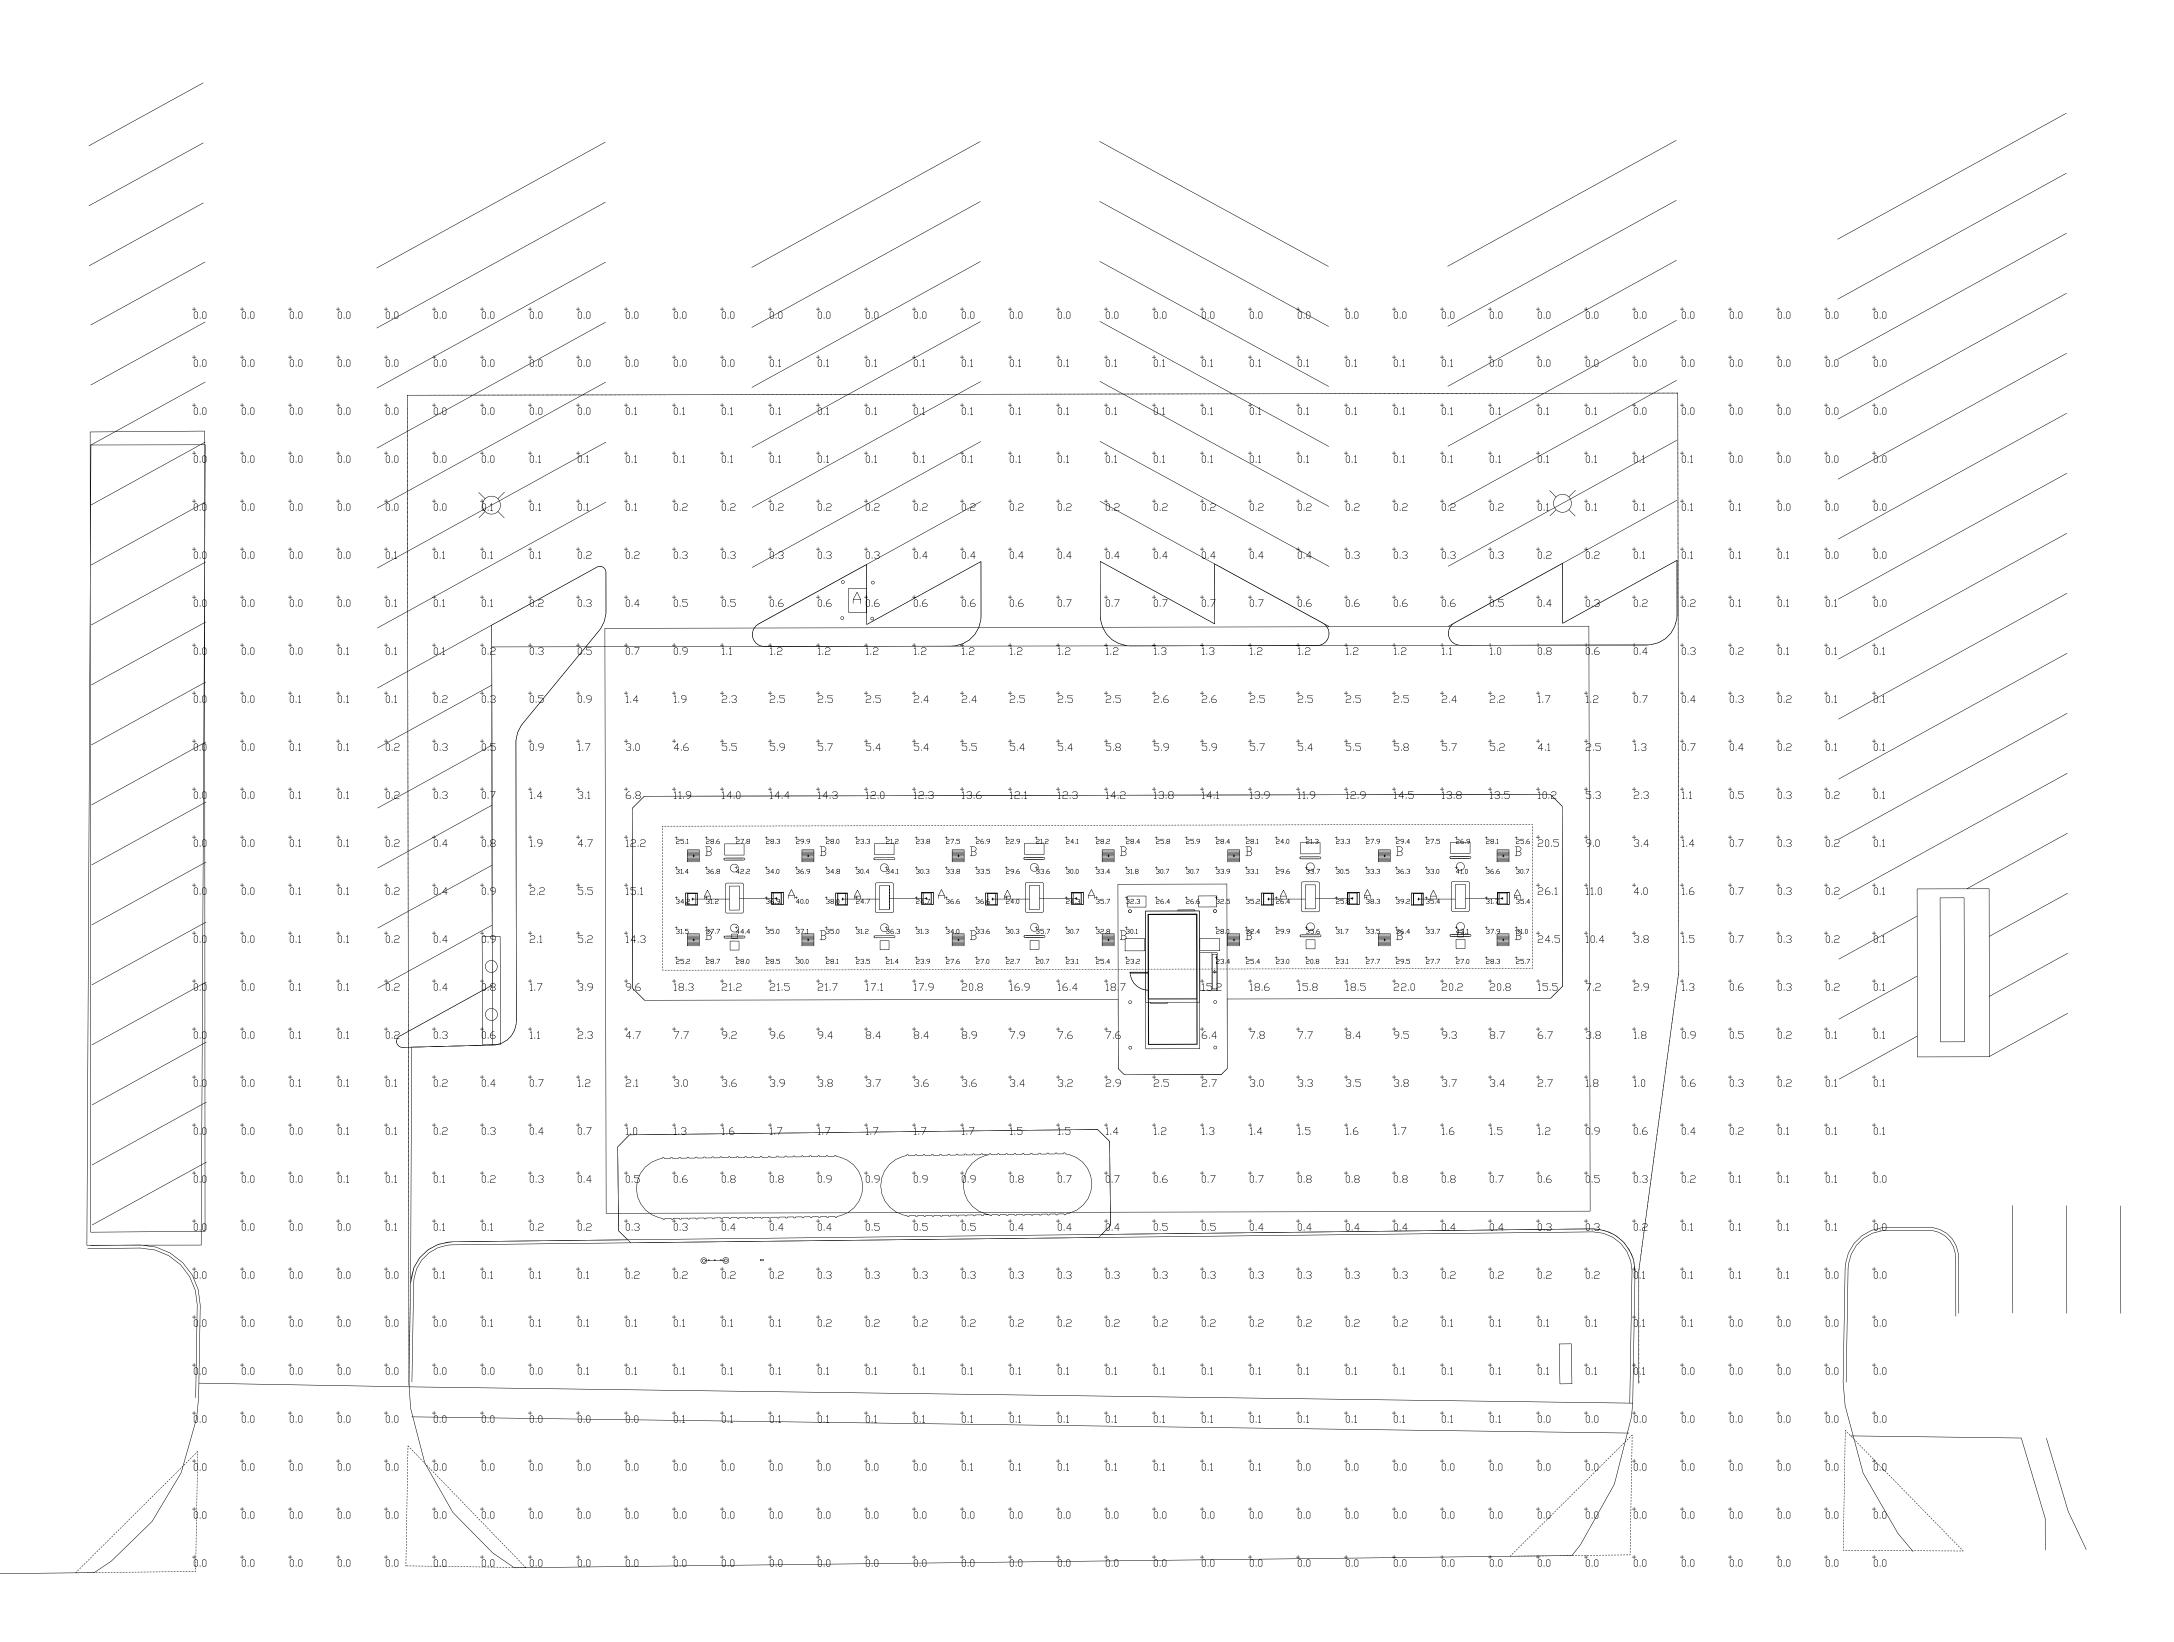
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DESIGN BY

DESIGN BY

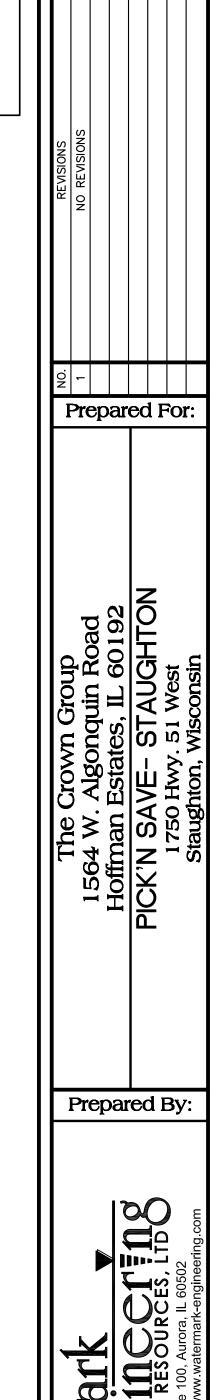DATE: MAR

SCALE: 1"

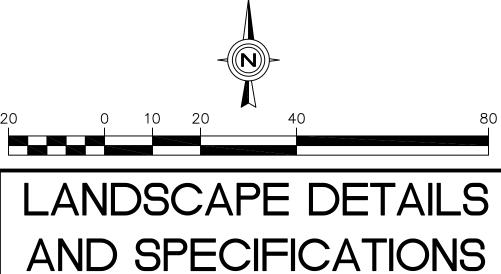


Luminaire Schedule										
Symbol	Qty	Label	Arrangement	Description	LLF	Lumens/Lamp	Arr. Lum. Lumens	Arr. Watts		
÷	10	А	SINGLE	CRO3-FO-LED-30-SS-CW-UE MTD @ 15'	1.000	N.A.	2674	36.1		
	14	В	SINGLE	CRUS-SC-LED-SS-50 MTD @ 15'	1.000	N.A.	13674	97.9		

Based on the information provided, all dimensions and luminaire locations shown represent recommended positions. The engineer and/or architect must determine the applicability of the layout to existing or future field conditions.

This lighting plan represents illumination levels calculated from laboratory data taken under controlled conditions in accordance with The Illuminating Engineering Society (IES) approved methods. Actual performance of any manufacturer's luminaires may vary due to changes in electrical voltage, tolerance in lamps/LED's and other variable field conditions. Calculations do not include obstructions such as buildings, curbs, landscaping, or any other architectural elements unless noted.

| Calculation Summary CalcType Avg/Min Max/Min Units Avg ALL CALC POINTS Fc 1.49 26.1 0.0 N.A. N.A. Illuminance 20.7 FC 30,20 CANOPY 44,4 1,46 2.14 Illuminance 21.2 5.02 PUMP_VERTICAL Fc 49.59 106.5 2.34 Illuminance INSIDE FUEL AREA Fc 6.18 0.5 12.36 52,20 Illuminance 26.1

CRO3 FO LED Focus (Single Deck)

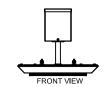











CRUS-SC-LED

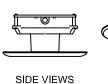

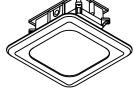

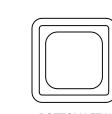

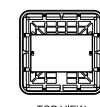

Total Project Watts


Total Watts = 1731.6



LIGHTING PROPOSAL LD-139216 PICK N SAVE #390 1750 HWY 51 WEST

STOUGHTON,WI DATE:8-03-17

SCALE: 1"=16'

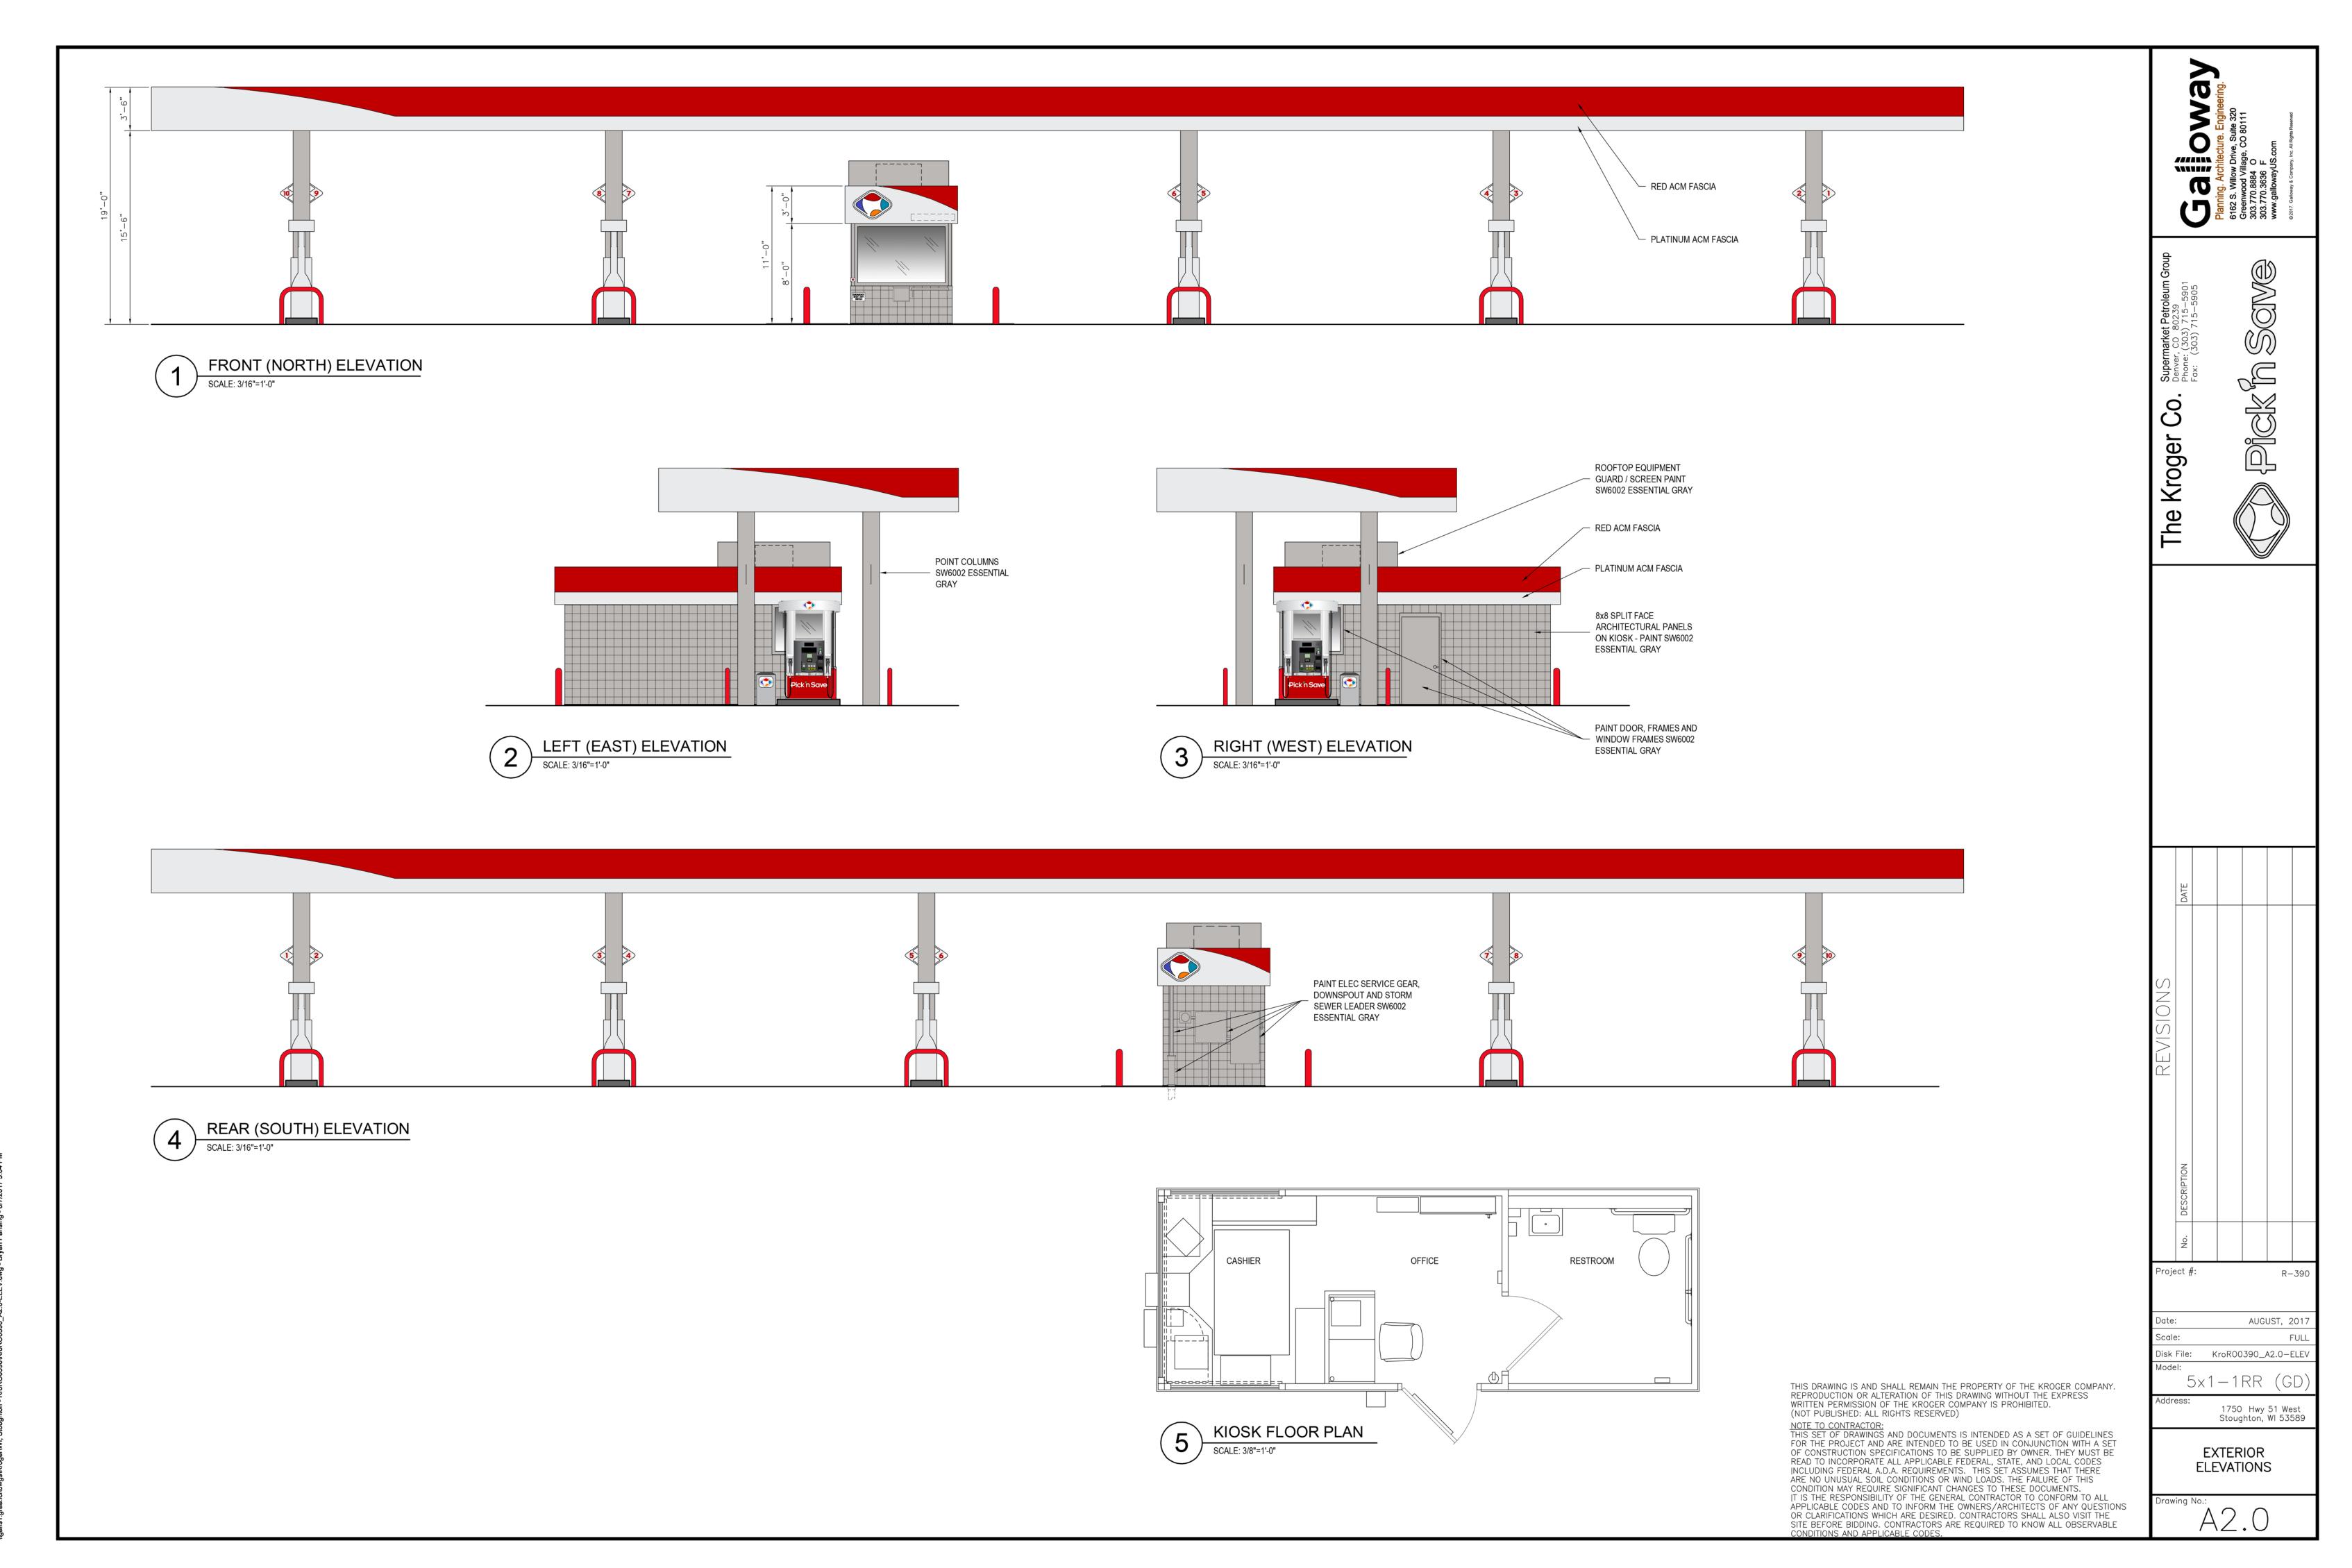

III Justification of the Proposed Conditional Use Request.

The prop	osed fue	el fac	ilitv	is util	izina	existi	na deve	loped
				station				
future l	and use	plan.						
(see Section 7	8-905(4)(d)),	result in a	ny substa	oosed location	adverse:	impact on n	earby prope	rty, the
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see Section 7 character of toublic proper either as they che provisions ordinance add The project unduction or unduction existing existing environment affecting affecting affecting character of the project of the pro	8-905(4)(d)), the neighborh ty or rights-one exist or sof the Zonio opted? Dosed further advers the exist of	result in an cood, enviring f-way, or coast hey mang Ordina el face impating garchituts. actors ublic	conmentation of the following substates on the following in the following	ntial or undue I factors, traff ters affecting tuture be deve Comprehensiv will no The fue y and wi haracter ffic fac	adverse ic factors the public loped as we Plan, o et result stall be all be tors, rights	impact on none, parking, pure health, safe a result of the rany other sult in tion is compled locate he neighbor parking parking compled to the neighbor parking compled to the neighbor parking parking parking parking continuous to the neighbor parking continuous to the ne	earby proper ablic improvety, or generable implementary any subtain an and mentary dependent of public, or ot	erty, the ements, al welfare, natation of m, map or estanticillary to the een two ed, c.c.

	How does the proposed conditional use maintain the desired consistency of land uses, land use intensities, and land use impacts as related to the surroundings of the subject property?							
	The fuel station will be constructed on a fully developed							
	parcel resulting in no land use impacts. The fuel station							
	will be designed to be complementary to the existing store							
	and is consistent with the public's expectations for a mod							
	grocery store offering.							
2	Is the proposed conditional use located in an area that will be adequately served by and will not impound an undue burden on any of the improvements, facilities, utilities or services provided by public agencies serving the subject property?							
	The fuel station will not be a burden on public or private							
	utilities.							
	Do the potential public benefits of the proposed conditional use outweigh all potential adverse impacts of the proposed conditional use (as identified in Subsections 78-905(5)(c)1-5.), after taking into consideration any proposed options to minimize such impacts?							
	The fuel facility will provide a public benefit for the							
	residents. The fuel station will not any adverse impacts							
	which would be contrary to Section 78-905.							

(a) A written description of the intended use describing in reasonable detail the following:

Existing zoning district: Planned Business

Planned Land Use Map designations (s): Planned Mixed Use

Current land uses present on the subject property: Pick'n Save Grocery Store and adjacent tenants

Proposed land uses for the subject property: *Pick'n Save Grocery store with new retail fuel facility, Good Will store and a Tractor Supply store*

Projected number of resident, employees, and daily customers. *No residents are expected on the commercial property. The fuel station will have 1 person per shift, for three (3) shifts.*

Proposed amount of dwelling units, floor area, impervious surface area, and landscape surface area, and resulting site density, floor area ration, impervious surface area ration, and landscape surface area ration. The proposed fuel facility will be constructed within a completely paved area of the existing parking lot. The fuel facility will be a department of the existing Pick'n Save grocery store utilizing Pick'n Save employees. The fuel facility will consist of a 24' x 145' fuel canopy, a 178 square foot transaction kiosk, five multi-product fuel dispensers, and two underground storage tanks. A color elevation of the proposed fuel facility is attached. The proposed construction will maintain existing drainage patterns and not result in an increase in impervious area. The proposed construction will not have any impact on surrounding landscape. Additionally, the property owner has conducted a site line survey to verify the proposed construction will not have a negative impact on the development of the main shopping center.


Pick'n Save will lease the fuel station premises as an amendment to their current lease with the property owner. Pick'n Save will continue to maintain their property as well as the additional fuel area.



Sto ARCHITECTURE, LLC 4417 N. MURRAY AVENUE SHOREWOOD, WI 53211

OUT LOT DEVELOPMENT 1710 SOUTH MAIN STREET

WEST BEND, WI

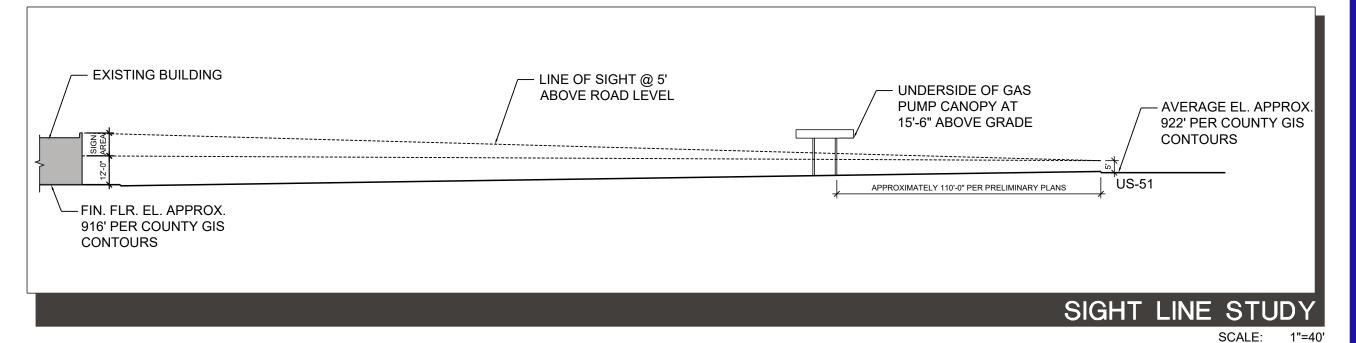



PROJECT NO. 1616

DATE 07-06-17

ехнівіт 🗛



CITY OF STOUGHTON DEPARTMENT OF PLANNING & DEVELOPMENT

381 East Main Street, Stoughton, WI. 53589

(608) 873-6619

www.ci.stoughton.wi.us

RODNEY J. SCHEEL DIRECTOR

September 1, 2017

Sevan Solutions Matthew Pisko 37704 Hills Tech Drive Farmington Hills, MI. 48331

Dear Mr. Pisko:

I have completed a final review of the proposed conditional use permit and site plan approval request for the Pick and Save Fueling Station at 1750 US Highway 51 and 138 – plans dated 8-10-17.

- 1. The property at 1750 US Highway 51 & 138 is zoned PB Planned Business. A public hearing has been scheduled for September 11, 2017 for the conditional use permit request. The Common Council will likely review your request on September 26, 2017. The site plan will be reviewed and potentially approved by the Planning Commission on September 11th contingent on the conditional use being approved by Council.
- 2. The following use is allowable as an accessory conditional use:

<u>In-vehicle sales or service</u> is defined as follows: In-vehicle sales and service land uses include all land uses which perform sales and/or services to persons in vehicles, or to vehicles which may or may not be occupied at the time of such activity (except vehicle repair and maintenance services, see subsection 78-206(4)(q)). Such land uses often have traffic volumes which exhibit their highest levels concurrent with peak traffic flows on adjacent roads. Examples of such land uses include drive-in, drive-up, and drive-through facilities, <u>vehicular fuel stations</u>, and all forms of car washes. If performed in conjunction with a principal land use (for example, a convenience store, restaurant or bank), in-vehicle sales and service land uses shall be considered an <u>accessory use</u> (see subsection 78-206(8)(g)).

- 3. The following regulations apply to in-vehicle sales or service:
 - a. Clearly marked pedestrian crosswalks shall be provided for each walk-in customer access to the facility adjacent to the drive-through lane(s). The kiosk will not be a walk-in facility.
 - b. The drive-through facility shall be designed so as to not impede or impair vehicular and pedestrian traffic movement, or exacerbate the potential for pedestrian/vehicular conflicts. **This design is typical of most fuel stations.**
 - c. In no instance shall a drive-through facility be permitted to operate which endangers the public safety, even if such land use has been permitted under the provisions of this section. **Expected.**
 - d. The setback of any overhead canopy or similar structure shall be a minimum of ten feet from all street rights-of-way lines, a minimum of 20 feet from all residentially-zoned property lines, and shall be a minimum of five feet from all other property lines. The total height of any overhead canopy or similar structure shall not exceed 20 feet per the measurement of roof height. **The canopy meets this requirement.**
 - e. All vehicular areas of the facility shall provide a surface paved with concrete or bituminous material which is designed to meet the requirements of a minimum four ton axle load. **The plan meets this requirement.**
 - f. Facility shall provide a bufferyard with a minimum opacity of .60 along all property borders abutting residentially zoned property (section 78-610). **There are no abutting residentially zoned properties.**
 - g. Interior curbs shall be used to separate driving areas from exterior fixtures such as fuel pumps, vacuums, menu boards, canopy supports and landscaped islands. Said curbs shall be a minimum of six inches high and be of a non-mountable design. No curb protecting an exterior fixture shall be located closer than 25 feet to all property lines. The pumps sit on raised concrete and bollards are used to protect the pumps which is typical of most fuel stations.
- 4. The following use is an allowable accessory use:
 - <u>Outdoor display incidental to indoor sales</u> include all land uses which conduct sales, <u>display sales</u> or rental merchandise or equipment <u>outside of an enclosed building</u>. The area of outdoor sales shall be calculated as the area which would be enclosed by a required physical separation installed and continually maintained in the most efficient manner which completely encloses all materials displayed outdoors. <u>Outdoor display incidental to indoor sales and service is allowable as an accessory conditional use as long as the display area does not exceed 25% of the gross floor area of the principal structure including the <u>following conditions</u>: <u>Outdoor display of product is proposed</u>. The Pick n Save main **building is the principal structure**.</u>
- 5. The following regulations apply to an outdoor display use:

- a. The display of items shall not be permitted in permanently protected green space areas, required landscaped areas, or required bufferyards. **N/A**
- b. The display of items shall not be permitted within five feet of a property line. N/A
- c. In no event shall the display of items reduce or inhibit the use or number of parking stalls provided on the property below the requirement established by the provisions of section 78-704. If the number of provided parking stalls on the property is already less than the requirement, such display area shall not further reduce the number of parking stalls already present. **N/A**
- d. Display areas shall be separated from any circulation area by a minimum of five feet.
 This separation shall be clearly delimited by a physical separation such as a greenway, curb, fence, or line of planters, or by a clearly marked paved area.

 Outdoor display is proposed adjacent to the kiosk and at the end of the dispenser islands. There will likely not be 5 feet of separation at the dispenser island but that area is protected by a nesting cage per plan.
- e. Signs, screening, enclosures, landscaping, or materials being displayed shall not interfere in any manner with either on-site or off-site traffic visibility, including potential traffic/traffic and traffic/pedestrian conflicts. **Expected.**
- f. Outdoor display shall be permitted during the entire calendar year, however, if goods are removed from the display area all support fixtures used to display the goods shall be removed within ten calendar days of the goods' removal. **Expected.**
- g. Inoperative vehicles or equipment, or other items typically stored or displayed in a junkyard or salvage yard, shall not be displayed for this land use. **Expected.**
- h. Facility shall provide a bufferyard with a minimum opacity of .60 along all borders of the display area abutting residentially zoned property, except per subsection e., above (See section 78-610.). **N/A**
- 6. The parking requirement for indoor sales and in-vehicle sales uses are one space per 300 square feet of gross floor area. Currently, the whole campus of Pick n Save, Tractor Supply and Goodwill combined require 311 parking stalls. There are 379 stalls proposed.
- 7. Handicapped parking spaces shall be provided at a size, number, location and with signage as specified by state and federal regulations. **This is expected.**
- 8. Required off-street parking and traffic circulation areas shall not be used for snow storage. **Snow storage areas are shown on the plan.**
- 9. The minimum landscape surface ratio (LSR) is 25 percent. The proposed gas station will not increase impervious surfaces. The plan indicates this requirement is met.
- 10. The required aisle width for 60 degree parking is 16 feet. **The plan meets this requirement.**

- 11. Parking stalls shall be 9 feet wide and 18 feet in depth. **Expected.**
- 12. The Comprehensive Plan, planned land use map designates this property as Planned Mixed-Use. **This designation meets the proposed use and zoning.**
- 13. Per section 78-704 (13)(a), bicycle parking is required equal to 5% of the automobile parking space requirement. The whole campus would need 16 bike stalls.
- 14. There are minimal landscaping requirements for this proposal. A landscaping plan has been submitted for along the front or US Highway 51-138 side as previously discussed at a prior Planning meeting.
- 15. Article VII of the city zoning code provides the following requirements related to lighting: "Parking and traffic circulation areas serving 6 or more vehicles shall be lit so as to ensure the safe and efficient use of said areas during the hours of use. An illumination level of between 0.4 and 1.0 footcandles is recommended for said areas, and said illumination shall not exceed 0.5 footcandles measured at the property lines." Section 78-707, Exterior lighting standards, requires a maximum average on-site lighting of 2.4 footcandles. The maximum lighting requirement as measured at the property line is 0.5 footcandles. Exterior lighting shall be oriented so that the lighting element is not visible from a property located within a residential district. A photometric plan has been provided. The lighting element shall be oriented so that it is not visible from a residential district.
- 16. A 10' x 50' loading stall shall be delineated on the plan for fuel trucks. **There is ample room to meet this requirement.**
- 17. Traffic generated by any use shall be channelized and controlled in a manner which avoids congestion on public streets and other safety hazards. Traffic control devices shall be required as determined by the director of planning and development. As determined by the director of planning and development.
- 18. Site circulation shall be designed to provide for the safe and efficient movement of all traffic entering, exiting, and on the site. Circulation shall be provided to meet the individual needs of the site with specific mixing of access and through movements. The applicant will provide details related to other similar sites. The fuel pumps are primarily used by Pick n Save customers.
- 19. All proposed signage must meet the requirements of ArticleVIII. **Details will be necessary** for any proposed new signage.
- 20. The kiosk is required to employ only high quality, decorative exterior construction materials on the visible exterior. Architectural and design elements shall be compatible with the surrounding area and community standards and shall minimize user-specific design elements as determined appropriate by the plan commission. **Exterior sample materials** have been provided for review.

- 21. A stormwater management and erosion control plan are necessary when more than 4,000 square feet of area is excavated for redevelopment. The plans, applications and fees shall be submitted to the Department of Planning & Development office at City Hall.
- 22. Electric, water and wastewater services are shown on the utility plan. A street opening permit from the Stoughton Street Department (608-873-6303) will be necessary for any work in the street right-of-way. Contact Stoughton Utilities regarding electric, wastewater and water services at 608-873-3379.
- 23. Terrace trees may be required per section 10-2(d). Contact Public Works Director Brett Hebert regarding terrace trees at 608-873-6303. **Terrace trees need to be addressed prior to permit issuance.**
- 24. State of Wisconsin approved building plans may be necessary prior to issuance of a building permit but are not necessary to begin the City review process.

If you have any questions, please contact me at 608-646-0421

Sincerely,

City of Stoughton

Michael P. Stacey

Michael P. Stacey Zoning Administrator/Assistant Planner

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